MAGNOLIA ENTRANCE FACILITY - UTILITIES PLAN

FOR BALDWIN COUNTY

MAGNOLIA LANDFILL SUMMERDALE, AL March 2023



- Q man	E Sunt	PROJECT LOCATION LAT: 30°26'30"N LONG: 87°45'59"W
, B		The state of the s
Terre Total Constitution of Terre		En loss
The same of the sa	Sign Park	

BALDWIN COUNTY COMMISSION

DISTRICT 1 HONORABLE JAMES E. (JEB) BALL

DISTRICT 2 HONORABLE JOE DAVIS, III

DISTRICT 3 HONORABLE BILLIE JO UNDERWOOD

DISTRICT 4 HONORABLE CHARLES F. (SKIP) GRUBER

> SOLID WASTE DIRECTOR TERRI GRAHAM

> > DEPUTY DIRECTOR ED FOX

INDEX TO SHEETS		
Sheet Number	Sheet Title	
-	TITLE SHEET	
C-102	NOTES AND LEGEND	
C-301	SITE UTILITIES PLAN	
C-302	WATER MAIN EXTENSION	
C-801	DETAILS	
C-802	DETAILS	
C-803	DETAILS	

NOT TO SCALE SITE ADDRESS:

MAGNOLIA LANDFILL 15140 CO RD 49 SUMMERDALE, AL 36580





ANDALUSIA, AL GADSDEN, AUBURN, AL HOOVER, A DOTHAN, AL HUNTSVILLE

CDG PROJECT NUMBER: R079321638

PROJECT NOTES

GENERAL NOTES:

- CDG INC. (CDG) SHALL NOT HAVE AUTHORITY OVER THE SITE OR BUILDING CONTRACTOR'S WORK OR RESPONSIBILITIES. CDG IS NOT RESPONSIBLE FOR SITE SAFETY PROCEDURES OR METHODS OF CONSTRUCTION.
- ALL EXISTING IMPROVEMENTS SHALL REMAIN UNLESS SPECIFICALLY NOTED HERECAL UPON FIELD VERIFICATION, IF ANY OF THESE IMPROVEMENTS CONFLICT WITH PROPOSED DESIGN, CONSULT WITH CDG PRIOR TO REMOVAL.
- CODINC, CODI, SHALL NOT BE RESPONSIBLE FOR ERRORS AND OMISSIONS RESULTING FROM DESIGN MODIFICATIONS MADE ATTER THE RECORD DATE OF THISSE PLANS SHOWN HERROR ALGUSTEMENTS TO THESE PLANS MAY BE INCESSARY, PER OWNER REQUEST THE CONTRACTOR IS RESPONSIBLE FOR THE FURCHASE OF CONTRACTORS LICENSE AND DISSIPLESS LICENSE FOR THE CONTRACTOR OF COUNTY AS A PAPICABLE. AS WELL AS ALL OTHER LICENSES AND PERMITS REQUIRED FOR COMPLETION OF THE WORK.
- 4. EXCEPT FOR EMERGENCY WORK, WORK SHALL NOT BE PERFORMED ON SATURDAY, SUNDAY, OR ANY LEGAL HOLDAY WITHOUT APPROVAL OF THE OWNER AND DIGNETER WORK SHALL GOOLD FURNING REASONABLE DAY-TIME HOURS REQUESTED REVENTIONS FORD THIS SOCIEDULE SHALL BE MADE TO THE BENDIERE ON LO CASESY-CASE BASISSA MINIMUM OF 72 HOURS PRIOR. EXCEPT FOR EMERGENGES. IN WHICH CASE HO SUCH APPROVAL IS REQUIRED.
- THE CONTRACTOR SHALL AT A MENUAL COMPLETE SATISFACTORY ROUGH GRADING, ROCK REMOVAL, AND TEMPORARY SEEDERS HOLD ATER THAN 15 DAYS FOLDOWN SHITLE, REQUIND ESTUBBLANCE, THE CONTRACTOR SHALL BE RESPONSIBLE FOR RE-CRADING. FERTILIZATION, WATERIO, AND RE-SELICIA AS REQUIRED TO SHALL BE RESPONSIBLE FOR RECOURSED TO SHALL THE CONTRACTOR SHALL BE AND RECOVERY WITHOUT SHALL SHALL PREVIOUS REPRESENTANCE OF PROPERTY OF THE RECOVER OF THE CONTRACT OF THE
- THE CONTRACTOR IS RESPONSIBLE FOR DOCUMENTATION OF EXISTING CONDITIONS PRESENT WITHIN AND ADJUGENT TO THE CONSTRUCTION AREA. DOCUMENTATION OF EXISTING CONDITIONS SHALL CONSIST SHALL DESIGN ADDITIONS SHALL DESIGN SHALL DESIGN SHALL DESIGN SHALL DESIGN SHALL DESIGN SHALL DESIGN SHALL SHALL BE DELIMITED TO THE EXIGINEER PRIOR TO BEGINNING CONSTRUCTION ACTIVITIES, DOCUMENTATION OF EXISTING CONDITIONS IN SEQUENCE TO AND CLAMBE FOR DAMAGE TO PROPERTY.
- 7. THE CONTRACTOR SHALL BE RESPONSIBLE FOR ANY DAMAGE CAUSED BY HIS ACTIVITIES IN THE PROJECT AREA. WHETHER ON BUILD OR PRIVATE PROPERTY, DAMAGE SHALL BE REPAIRED TO PRE-CONSTRUCTION CONDITIONS OR BETTER, AND TO THE SATISFACTION OF THE ENGINEER AND LAND OWNERIS, REPAIRS SHALL BE MADE AT THE CONTRACTORS EXPENSE.
- THE CONTRACTOR SHALL COORDINATE ALL CONSTRUCTION ACTIVITY IN THE PROJECT AREA WITH THE COUNTY, CITY, AND STATE, AS APPLICABLE.
- THE CONTRACTOR SHALL TAKE NECESSARY PRECAUTIONS AS TO NOT DISTURB PROPERTY CORNERROW MARKERS AND BENICHMARKS. IT SHALL BE THE CONTRACTOR RESPONSIBILITY, INCLUDING ANY REQUIRED SURVEYING, TO REPLACE ANY DISTURBED MARKERS ANDOR MONIMENTS.
- WHERE APPLICABLE. THE CONTRACTOR IS RESPONSIBLE FOR PROVIDING AND MAINTAINING TRAFFIC CONTROL IN ACCORDANCE WITH THE RECUIREMENTS OF PART 6 OF THE MUTCO, LATEST EDITION, AND IN ACCORDANCE WITH ANY ATTACHED TRAFFIC CONTROL PLAN.
- 11, UNLESS APPROVED IN ADVANCE BY THE ENGINEER THE CONTRACTOR SHALL MAINTAIN ACCESS FOR THE TRAVELING PUBLIC, BERGERENCY, AND SCHOOL, VEHICLES AT ALL TIMES ALOXIA ALL CITY, COUNTY, AND THE RIGISTIS OF WAY, IF A ROAD, CLOSER IS HALLOWED. THE CONTRACTOR SHALL BE RESPONSIBLE FOR COORDINAT SHAD ALCORDING WITH THOSE PARTIES REQUIREMENTS.
- 12. DRIVEWAYS WHICH MAY HAVE BEEN OUT OR OTHERWISE DAMAGED DURING THE CONSTRUCTION ACTIVITIES SHALL BE MAINTAINED IN A USABLE CONDITION FOR THE DURATION OF THE PROJECT, THE CONTRACTOR SHALL MAKE A REASONABLE EFFORT TO RE-OPEN DRIVEWAYS AS SOON AS POSSIBLE. IN NO CASE SHALL DRIVEWAYS BE CLOSED
- 12. ALL EQUIPMENT SHALL BE PARKED AND ALL MATERIALS SHALL BE STORED AT A LOCATION OUTSIDE THE PUBLIC RIGHT OF WAY AT A LOCATION OF THE CONTRACTOR'S CHOOSING, PRICE TO FIRM, PAYMENT, THE CONTRACTOR SHALL PROTYPE WHITEN NOTICE FROM THE COMES OF SUCH PARKING AND STORAGE AFRAGIS, THAT THE AREA(S), HAVE BEEN RESTORED TO LAND COMERTS SATISFACTION, AND THE TERMS ASSOCIATED WITH ANY SUCH ARRANGEMENTS HAVE BEEN ARTISFED.
- 14. EXISTING DRAINAGE SYSTEMS SHALL REMAIN FULLY OPEN THROUGHOUT THE PROJECT DURATION, ANY DISTURBANCE OR DIMAGE TO EXISTING DRAINAGE SYSTEMS AND STRUCTURES SHALL BE REPAIRED OR REPLACED TO THE SATISFACTION OF THE ENGINEER AND THE CITY, COUNTY, AND/OR STATE AT NO ADDITIONAL COST TO THE OWNER.
- 16. EXCEPT FOR WHERE THE FLANS STATE OTHERWISE, OR THE PLANS REQUIRE EMPORARY CONSTRUCTION THEIRING TO BE INSTALLED THATING FERDES SHOULD THE REMOVED, RELOCATED ON OTHERWISE DIAMOGED DURING THE CONSTRUCTION ACTIVITIES, REMOVED, RELOCATED, OR DAMAGED FENDES SHALL THE SATISFACTION OF THE EMPOREM AND AND OWNER AT HO ACCOUNTING. COST OF THE OWNER,
- RESIDENTS AND BUSINESS SHALL NOT BE LIST WITHOUT MALE SERVICE. IF A MULIDOX MUST BE MOVED TO FAQUITATE CONSTRUCTION, IT SHALL BE TEMPORARY AND SATES-NOTOMEY RELOCATED AS CLOSE AS PRACTICABLE TO ITS DRIBANAL LOCATION, AND IN ACCORDANCE WITH UNITED STATES POST OFFICE GUIDELINES FOR MALBOX PLOCEURIT.
- JOB SITE SHALL BE CLEANED ON A DAILY BASIS. THE CONTRACTOR SHALL RESTORE ALL AREAS, WHETHER PUBLIC CR PRIVATE, AS SOON AS PRACTICABLE FOLLOWING COMPLETION OF PARTICULAR CONSTRUCTION ACTIVITIES.
- 18. THE CONTRACTOR SHALL REPAIR ALL EXCAVATED AREAS, BACKFILLS, EMBANKMENTS, TRENCHES, AND DITCHES WHICH MAY HAVE SETFLED AT NO ADDITIONAL COST TO WAILUIT HILL WATER AUTHORITY UNTIL FINAL ACCIEPTANCE OF THE PROJECT AND THROUGHOUT THE WARRANTY PERFOX, ALL SUCH AREAS SHALL BE RESTORED TO PRE-CONSTRUCTION CONTOURS.
- 26. THE CONTRICTOR BESENCHESIE FOR MAINTAINING ALL GRISSED AREA 6.THE SUPERIE UNTL. FINAL ACCEPTANCE AND THROUGHOUTH EWARRANT PRESIDE MAINTENANCE OF GRASSED AREAS SHALL INCLUDE RECAPACING, RE-FERILLATION, RE-SEEDING, WATERING, AND ANY OTHER WORK AS REQUIRED, TO PRODUCE AND KEEP THE GRESS IN A CONCINTION ACCEPTABLE TO THE EXPRICER AND AUTOMATION AND THE CONCINTION ACCEPTABLE TO THE EXPRICER AND AUTOMATION AND ACCEPTING GRESS IN A CONCINTION ACCEPTABLE TO THE EXPRICER AND AUTOMATION AND ACCEPTING GRESS IN A CONCINTION ACCEPTABLE TO THE EXPRICER AND AUTOMATION AND ACCEPTING GRESS IN A CONCINTION ACCEPTABLE TO THE EXPRICER AND AUTOMATION AND ACCEPTING THE ACCEPTANCE AND ACCEPTABLE TO THE EXPRICER AND AUTOMATION AND ACCEPTANCE AND ACCEPTANCE

UTILITY NOTES:

- EXETING UTILITIES ARE CEPICITED BASED ON FOUR (4) YOUALITY LEVELS' DEFINED AS FOLLOWS:

 QUALITY LEVEL A ROGERY HAZ, AND VERTICAL LOCATION COSTANDS BY ACTUAL EXPOSURE AND MEASUREMENT
 QUALITY LEVEL B APPROXIMATE LOCATION OBTAINED PROM SURFACE GEOPHYSICAL METHODS. NO DEPTH INFORMATION INCLUSED.
 QUALITY LEVEL C APPROXIMATE LOCATION SURVEYED AND PLOTTED BASED ON VISIBLE ABOVE GROUND UTILITY
- d. QUALITY LEVEL D INFORMATION DERIVED FROM EXISTING RECORDS AND/OR ORAL RECOLLECTIONS
- 2. ALL UTILITIES ARE DEPICTED AT "QUALITY LEVEL B" UNLESS INDICATED OTHERWISE AND LABELED AS "QL-C" OR
- 3. ANY "QUALITY LEVEL A" ELEVATIONS PROVIDED ARE FROM THE TOP OF THE UTILITY AT THE APPROXIMATE LOCATION SHOWN LIBITESS OTHERWISE NOTED.

- 4. NEITHER THE OWNER MORTHE ENGINEER MAKES ANY EXPRESSED OR IMPLIED GUARANTEE OF THE ACCURACY OF UTILITIES SHOWN OR AITY GUARANTEE THAT ALL UTILITIES LOCATED WITHIN THE CONSTRUCTION AREA ARE SHOWN MERIEN.
- THE CONTRACTOR SHALL CALL ALABAM CHE CALL AT \$11 FOR UTELTY MARRING PRICE TO COMMENCIAN. CONSTRUCTION IT SHALL BE THE CONTRACTOR SHEPCHABILITY TO DETERMINE THE SHALL DECEMBENC OF ALL UNCERFROUND UTLITIES BEFORE COMMENCING WORK, ANY DAMAGE TO EXISTING UTILITIES SHALL BE REPAIRED AT THE CONTRACTOR'S EXPENSE.
- THE CONTRACTOR SHALL COORDINATE ALL WORK ADJACENT TO EXISTING UTILITY POLES AND GUY WIRES WITH THE LOCAL POWER COMPAIN. THE CONTRACTOR SHALL CONTROT THE LOCAL POWER COMPAIN TO HOLD SAID UTILITY POLESGUY WIRES DURING BORING OR OPEN GUT OPERATIONS. THE COST OF THIS WORK SHALL BE CONSIDERED INCIDENTAL TO THE PROJECT AND IN ACCITIONAL PAYMENT WILL BE MODE.
- 7. THE CONTRACTOR SHALL COORDINATE ALL TIE-INS. CONNECTIONS OUTAGES, AND VALVING OPERATIONS WITH THE UTILITY OWNER, THE CONTRACTOR SHALL GIVE 72 HOURS NOTICE TO THE UTILITY OWNER OF WHEN SUCH OPERATIONS ARE TO TAKE PLACE.
- THE CONTRACTOR SHALL COORDINATE WITH AND PROVIDE REASONABLE NOTICE TO RESIDENTS AND BUSINESSES OF UTILITY SERVICE OUTAGES PRIOR TO BEGINNING SUCH OPERATIONS, NO RESIDENT OR BUSINESS SHALL BE LEFT WITH OUT SERVICE OVERWIGHT.
- ALL NEW MAINS SHALL BE INSTALLED AT LEAST 39" BELOW THE SURFACE, AT LOCATIONS WHERE THE REQUIRED MAIN IS TO CROSS AN EXISTING PUTLITY. THE MAIN SHALL BE PLACED A MINIMUM OF 24" ABOVE OR BELOW THE EXISTING MAIN, BUT NO LESS THAN 39" BELOW THE SURFACE.
- 10. RECORD DRAWNOS OF ALL MAIN AND ERVICE LIFE INSTALLATIONS SHALL BE PROVIDED BY THE CONTRICTOR. THESE DRAWNOS SHALL BICLIED HORIZONFAL LOCATIONS OF BIRST AND WAVES, SAVELA SIVETIME. LOCATIONS OF ANY MAINS INSTALLED DESPITE THAN THE STRAIGHTD SP DEPTH, DRAWNOS SHALL BE PROVIDED IN A GIS SHAPPILE FORMAT TO THE DRIGHER AND TO ALDOT.
- CONTRACTOR SHALL BE RESPONSIBLE FOR COORDINATING ALL UTILITY LOCATIONS WITH THE LOCAL UTILITIES.
 CONTACT WITH EACH UTILITY SHOULD BE MADE BEFORE ANY CONSTRUCTION BEGINS ON THIS PROJECT.
- COORDINATE ALL ELETRICAL IMPROVEMENTS TO AVOID CONFLICT WITH PROPOSED DESIGN AND EXISTING UTILITIES, ANGINEER SHALL APPROVE FINAL POLE LOCATIONS.

SITE NOTES:

- IT IS CONTRACTOR'S RESPONSIBILITY TO PROVIDE CONSTRUCTION LAYOUT AND GRADE STAKING, CDG WILL PROVIDE ELECTRONIC DESIGN FILES IN DWG FORMAT.
- IT IS THE CONTRACTOR'S RESPONSIBILITY TO PROTECT ALL BENCHMARKS AND PROPERTY CORNERS, ANY REPLACEMENT WILL BE AT THE CONTRACTOR'S EXPENSE.
- IT IS THE RESPONSIBILITY OF THE CONTRACTOR TO OBTAIN ALL NECESSARY PERMITS REQUIRED TO CONSTRUCT
 THIS PROJECT. ALL PERMITS MUST BE IN-HAND PRIOR TO CONSTRUCTION.
- ALL ADA ACCESSIBLE ROUTES, PARKING, RAMPS, CROSSWALKS, SIGNS, SYMBOLS, AND PAINTED ISLANDS MUST CONFORM TO THE LATEST ADA REQUIREMENTS.
- 5. TOPOGRAPHICAL (HORIZONTAL ONLY) AND CONTROL (HORIONTAL AND VERTICAL) SURVEYS PERFORMED BY CDG.
- 6. ALL DIMENSIONS ARE TO BACK OF CURB UNLESS OTHERWISE NOTED.
- NOTIFY ENGINEER IMMEDIATELY IF ANY ERRORS AND OMISSIONS ARE FOUND.
- 8. HORIZONTAL AND VERTICAL DATUMS USED IN DESIGN ARE NAD83 AL STATE PLANE WEST AND NAVD88
- 9. NO GRADING OFF-SITE OR IN ANY ROAD RIGHT-OF-WAY WITHOUT PROPER APPROVALS.
- 10. ALL GRADING ADJACENT TO EXISTING OR PROPOSED BUILDINGS SHALL BE SLOPED AWAY FROM THE STRUCTURES. THE CONTRACTOR SHALL ASSURE POSITIVE DRAINAGE AWAY FROM THE STRUCTURES. NOTIFY COG OF ANY DISCREPANCIES.
- PROPOSED GRADES INDICATED ON THIS PLAN ARE TO FINISH GRADE. THE CONTRACTOR SHALL MAKE SUBGRADE ADJUSTMENTS FOR TOPSOIL, PAVEMENT, BUILDING PAD, ETC.

FROSION AND SEDIMENT CONTROL NOTES:

- 1. SITE EROSION CONTROL MEASURES SHALL BE IN ACCORDANCE WITH ALL FEDERAL, STATE AND LOCAL LAWS, CODES, AND REGULATIONS.
- 2. THE LANDFILL SITE HAS AN NPDES PERMIT GOVERNING THE CONSTRUCTION OF THE PROJECT (PERMIT NO. AL009945). THE CONTRACTOR SHALL BE RESPONSIBLE FOR ALL MONITORING, INSPECTIONS, ETC. TO ENSURE THE CONNER THAT THE SITE IS AT ALL TIMES IN ACCORDANCE WITH ADEM RULES AND REGULATIONS.
- 3. ALL EROSION CONTROL MEASURES ARE TO BE MAINTAINED UNTIL PROJECT COMPLETIC
- 4. THE CONTRACTOR SHALL PROVIDE A BMP PLAN FOR APPROVAL BY THE ENGINEER PRIOR TO THE BEGINNING OF
- THE CONTRACTOR IS RESPONSIBLE FOR PROPERLY INSTALLING AND MAINTAINING SUFFICIENT EROSION CONTROL MEASURES AS MAY BE REQUIRED TO PREVENT SEDIMENT FROM DISCHARGING FROM THE SITE, AND IN COMPLIANCE WITH ANY PERMITS AND COMP.
- 6. ALL DISTURBED AREAS THAT DO NOT RECEIVE WORK FOR 13-DAYS SHALL BE TEMPORARY SEEDED AND MULCHED

	LEGEND		
EXISTING		PROPOSED	
	UTILITIES		
POWER POLE	ė i		
IGHT POLE	-0-	-8-	
ELEPHONE POLE	0		
ANCHOR	Δ	<u> </u>	
STUB (POWER)			
STUB (TELEPHONE)	-0-	***	
LECTRIC METER	0	0	
BURIED ELECTRIC CABLE		——BE———BE———	
OVERHEAD ELECTRIC CABLE			
ELECTRIC MANHOLE	0		
ELECTRIC TRANSFORMER			
TOWER	×	DEL	
TELEPHONE PEDESTAL	(1)	(1)	
BURED TELEPHONE CABLE		BTCBTC	
OVERHEAD TELEPHONE CABLE	otcotc		
BURIED FIBER OPTIC		BFOBFO	
TELEPHONE MANHOLE	[TMH]	TMH	
WATER MAIN			
WATER VALVE	A	Δ.	
FIRE HYDRANT	9	6	
WATER METER	×	Ž.	
GAS MAIN			
GAS VALVE	A	A	
GAS REGULATOR	1 1	6	
SANITARY SEWER	53	11	
FORCE MAIN	FWFW	FM	
SEWER MANHOLE	(6)	(3)	
AIR/VACUUM RELEASE VALVE		Ä	
CLEANOUT	0	0	
CLEAROUT	DRAINAGE		
DITCH LINE			
STORM MANHOLE	(10)	(in)	
STORM PIPE	stvstv	STM-STM-	
Storument	MISC		
SIGN			
MAILBOX	(350)	[MB]	
A/C UNIT	A	A	
BORING LOCATION OR TEST PIT		•	
WELL	((A))	Ó	
MONITORING WELL	AN I	- 8	
FLAG POLE	WYG		
SPOT ELEVATION			
FOUND IRON PIN	•	- 1mm	
		9	
SET IRON PIN	100	FQ.	
CONCRETE MARKER		- 0	
BENCHMARK	8		
TREES		—-R—-R—-R-	
PROPERTY LINE			
RIGHT-OF-WAY			
CHAIN LINK FENCE			
WOOD FENCE			
BARBED WIRE FENCE		xxx	
HOG WIRE FENCE	(t)(t)(t)	(X) (X) (X)	
	EROSION CONTROL		
	A		
SILT FENCE			
SILT FENCE CONTOUR MAJOR	GRADING	100	

	EXISTING	REQUIRED		EXISTING	REQUIRED
ASPHALT			RIP-RAP		
CONCRETE		900	WATER	3333	
GRAVEL			WOOD DECK		
AWNING					





11 W. COURT 8 P.O. BOX ANDALUSIA, A (334) H


PLAN VOTES AND LEGEND
A ENTRANCE FACILITY - UTILITIES PI
FOR BALDWIN COUNTY
SUMMERDALE, AL 0 ž MAGNOLIA


DRAFT

SCALE: AS SHOWN Mar-23 REVISED PROJECT NO: ROTO: SHEET NO. C-102

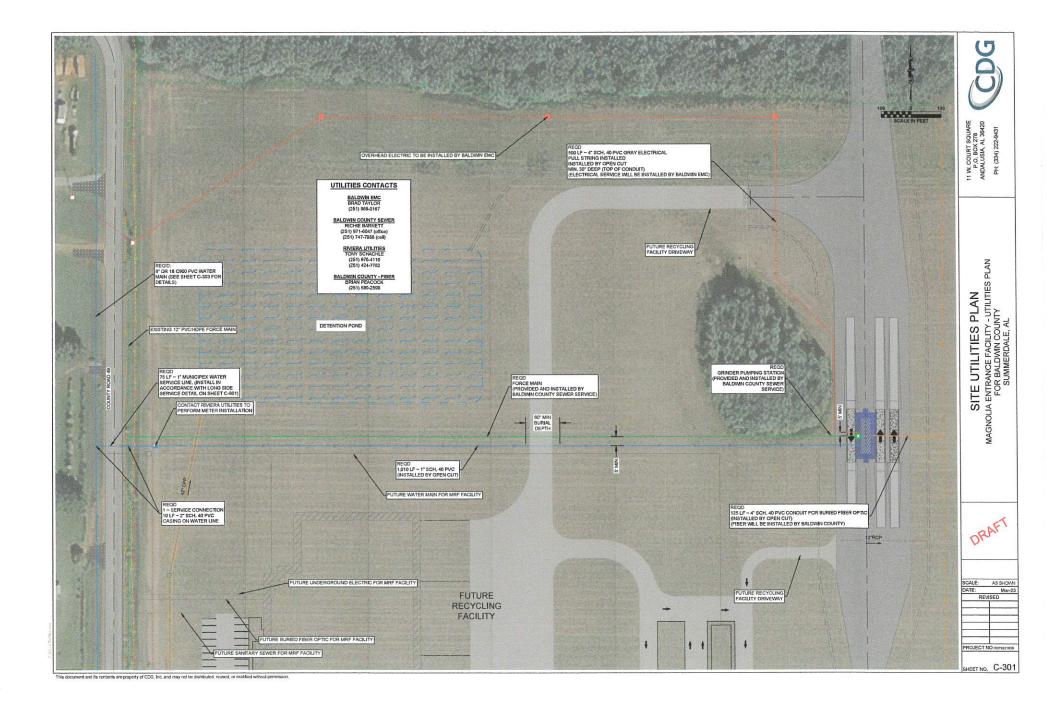

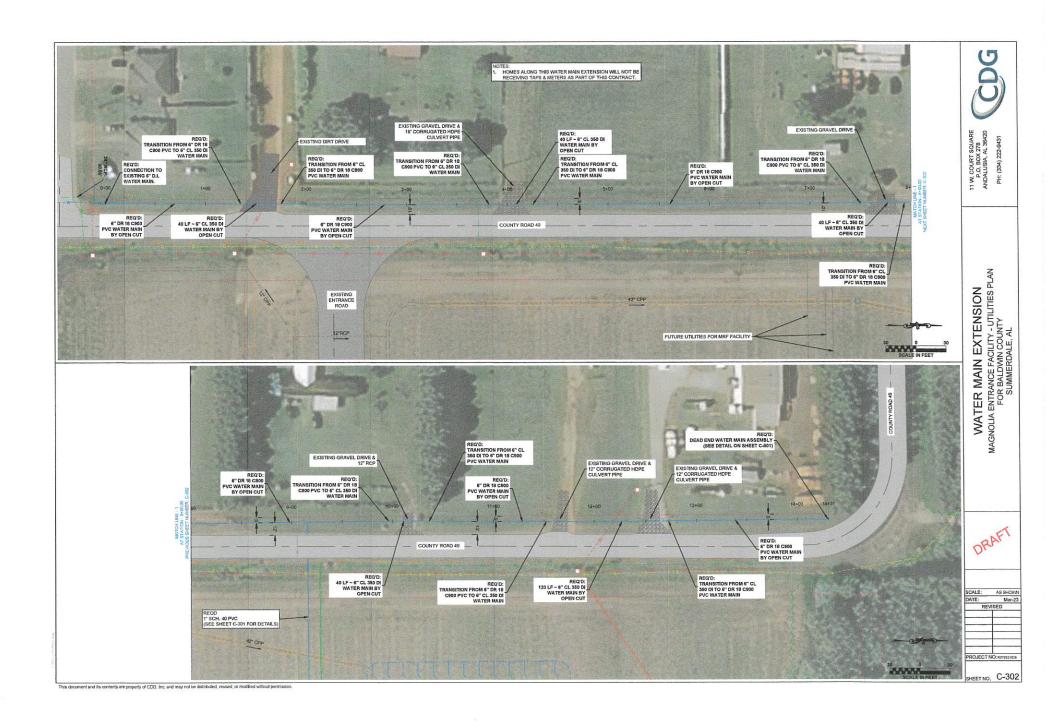

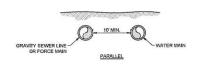


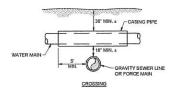

DETAILS OF UTILITY SEPARATION NOT TO SCALE

DETAIL NOTES

- 1. CORPORATION STOPS WHERE REQUIRED OR DIRECTED SHALL HAVE STANDARD CC CORPORATION CURPLY HEAD ON NEW HAS BEEN EQUIPLED BY ANY MENT OF SHARE STANDARD OF THE STANDARD OF THE SHARE MAINS ONLY BY MEANS OF A BRONZE SERVICE CLAMP (MUELLER H1300 SERIES, FORD S70 SERIES, OR
- 2. REFER TO RIVIERA UTILITIES' STANDARD SPECIFICATIONS FOR WATER MAINS, MOST RECENT VERSION, TO CONFIRM CURRENT SPECIFICATIONS AND MODEL NUMBERS FOR MATERIALS INDICATED ON THIS DETAIL. WHEN IN CONFLICT, THE STANDARD SPECIFICATIONS SHALL CONTROL.

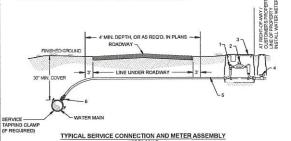


WATER METER MATERIAL SCHEDULE


- 1. METER YOKE
- A. I METER YOKE SHALL BE FORD LINE SETTER LSVBHH48-233W4Q-NL OR APPROVED EQUAL.
- B. 1" METER YOKE SHALL BE FORD LINE SETTER LSVBHH48-44-WASN-AQ-NL OR APPROVED EQUAL.
- C. 1.5" METER YOKE SHALL BE FORD LINE SETTER VBHH76-12HBHC-11-66-NL OR APPROVED EQUAL.
- D. 2.0" METER YOKE SHALL BE FORD LINE SETTER VBHH77-12HBHC-11-77-NL OR APPROVED EQUAL.
- WATER METER PROVIDED AND INSTALLED BY RIVIERA UTILITIES.
- 3. METER BOX AND COVER
- A. FOR P SERVICE METER BOX SHALL BE CARSON CLDCASTLE 1015-12 WITH A 1419
 FLUSH-MOUNTED LID WITH A 4.5-INCH OD
 RECESSED AMP OFFSET AND INTEGRAL METAL
 LOCATOR DEVICE, OR APPROVED EQUAL.
- B. FOR 1" SERVICE METER BOX SHALL BE CARSON OLDCASTLE 1220-12 WITH A FLUSH-MOUNTED LID WITH CAST IRON READER. OR APPROVED EQUAL.
- C. FOR 1.5' AND 2' BERVICES CARSON OLDCASTLE 1730-18 WITH A FLUSH-MOUNTED LID WITH CAST IRON READER, OR APPROVED EQUAL.

- CUSTOMER-SIDE SHUT-OFF VALVE. VALVE BOX AND SERVICE PIPING (BY OTHERS) INSTALLED BETWEEN ONE TO TWO FEET FROM THE METER BOX.
- SERVICE PIPING SHALL BE TYPE K COPPER TUBING (SEAMLESS WITH NO BENDS, JOINTS OR COMPRESS/OR COUPLINSS). CROSS-LIMED PEX (MUNICIPEX OR APPROVED EQUAL IS ACCEPTABLE FOR 1.5" AND 2" SERVICES WHERE APPROVED BY RIVERA UTILITIES.
- 6. CORPORATION STOPS
- A. *BALL-STYLE CORPORATION STOPS SHALL BE FORD FB1000-3-0-NL, MURLLER B25008004 *F. A.Y. MCDONALD 74701BQ *F. OR APPROVED EQUAL.
- ECUAL

 E 1º BALLSTYLE CORPORATION STOPS SHALL BE FORD REMODA-O-N. MURLLER BSSONGON 1º
 A.º. MCODALO-N. MURLLER BSSONGON 1º
 A.º. MCODALO-TATOBO 1º CAR PPROVADE COUAL, 1.5° SERVICES SHALL BE INSTALLED WITH A.º TAP AND 2° TYPE K. COOPER OR MUNICIPEX (OR APPROVED ECUIAL) WATER SERVICE LIBE. A 1º VAIL VERBALL BE INSTALLED RICK 10 METER FOX TO REDUCE TO THE 1.5° METER YORK.

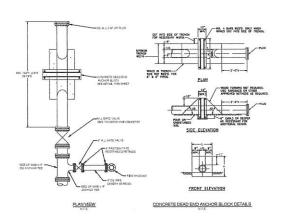

TYPICAL DEAD END WATER MAIN ASSEMBLY

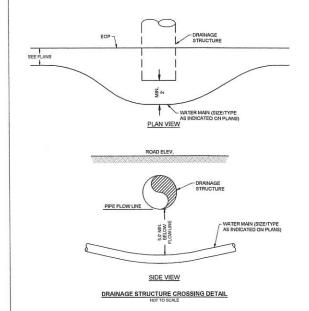

11 W. COURT SQUARE P.O. BOX 278 ANDALUSIA, AL 36420

PH: (334) 222-9431

DETAILS
ENTRANCE FACILITY - UTILITIES PLAN
FOR BALDWIN COUNTY
SUMMERDALE, AL

MAGNOLIA


DRAFT

PROJECT NO: R079321634

SHEET NO. C-801

AS SHOWN


Mar-23

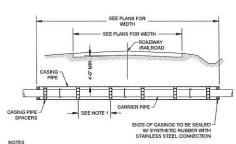

NOTES

- CASING PIPE SPACERS MIN. 4' APART OR AS
- CARRIER PIPE SHALL BE RESTRAINED GASKET OR FUSIBLE HDPE PIPE.
- 3 SEE DI AN SHEETS FOR CARRIER DIRE SIZE
- SEE PLANS FOR CASING PIPE SIZE AND MATERIAL THICKNESS.


CASING PIPE AND CARRIER PIPE UNDER PAVED ROADS AND RAILROADS

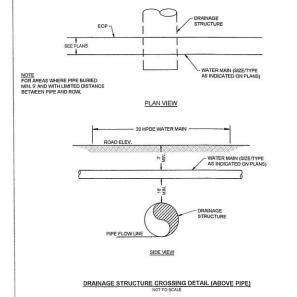


This document and its contents are property of CDG, Inc., and may not be distributed, reused, or modified without permission.



- 1. MAXIMUM COVER IS 60" UNLESS NOTED IN PLANS OR APPROVED BY THE
- MAXIMUM TRENCH WIDTH SHALL NOT EXCEED THE PIPE O.D. PLUS 12" MAXIMUM WIDTH ON BOTH SIDES OF UTILITY PIPE UNLESS NOTED OTHERWISE IN THE PLANS.
- PAYMENT FOR REQUIRED OFF-SITE FILL SHALL BE LIMITED TO THE MAXIMUM TRENCH WIDTH AS DEFINED IN NOTE #2 ABOVE.
- FOR ASPHALT DRIVEWAYS, A BINDER LAYER WILL NOT BE USED, WIDTH SHALL BE LIMITED TO THE UTILITY MAIN, PLUS 12" ON EACH SIDE.
- FOR GRAVEL DRIVEWAYS, A 6" CRUSHED AGGREGATE BASE COURSE SHALL BE PLACED TO MATCH THE ADJACENT SURFACE AND LIMITED TO THE WIOTH OF THE TRENCH.
- FOR CONCRETE PAVING REPLACEMENT, SUBSTITUTE ASPHALT WITH MIN. 6" OF 3,000 P. S.I. CONCRETE WITH FIBER-MESH, MATCH THICKNESS OF SURROUNDING CONCRETE.
- THE CONTRACTOR SHALL REPAIR ALL EXCAVATED AREAS, BACKFILS, EMBANAGENTS, FRENCHES, AND DITCHES WHICH MAY HAVE BETTLED. AT NO ADDITIONAL COST TO THE OWNER UNITE, FIRM, ACCEPTANCE OF THE PROJECT ARD THROUGHOUT THE VARIOUNT PERIOD. ALL SUCH AREAS SHALL BE RESTORED TO PRECOUNTRICTION CONTOURS.

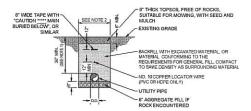


TYPICAL TRENCH DETAIL NON-STRUCTURAL AREAS

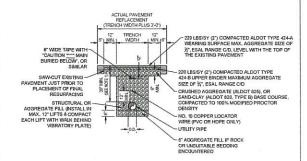

TYPICAL TRENCH DETAIL STRUCTURAL AREAS





PLAN

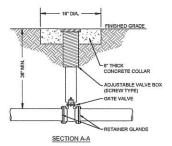


GATE VALVE AND BOX DETAIL NOT TO SCALE

- INSPECT AND REPAIR FENCE AFTER EACH STORM EVENT AND REMOVE SEDIMENT WHEN NECESSARY, 9" MAX, RECOMMENDED STORAGE HEIGHT,
- REMOVED SEDIMENT SHALL BE DEPOSITED TO AN AREA THAT WILL NOT CONTRIBUTE SEDIMENT OFF-SITE AND CAN BE PERMANENTLY STABILIZED,
- SILT FENCE WIRE FABRIC JOINTS SHALL OVERLAP A MIN, OF 2' AT POST AND FASTENED WITH MIN. 3 FASTENERS AND FILTER FABRIC SHALL OVERLAP A MIN. 2' AND FASTENED

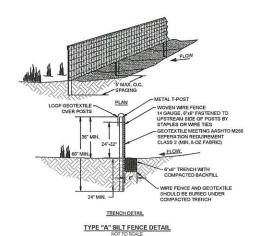

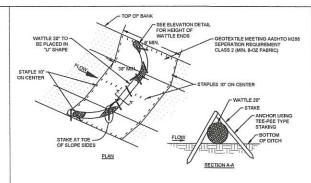


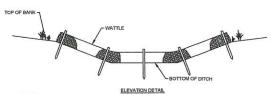

NOTES:

- MINIMUM RECOMMEND PLACEMENT INTERVAL SETWEEN WATTLE DITCH CHECK IS 100' UNLESS SHOWN OTHERWISE ON THE PLANS OR APPROVED
- ANCHORING STAKE SHALL BE SIZED, SPACED, DRIVEN AND BE OF A MATERIAL THAT EFFECTIVELY SECURES THE WATTLE, STAKE SPACING SHALL BE A MAXIMUM OF THREE FEET AND USE NON-DESTRUCTIVE TEE-PEE TYPE STAKING, ALL NON-DEGRADABLE MATERIALS SHALL BE REMOVED WHEN NO LONGER NEEDED.
- WATTLES MUST BE STAPLED WITH SOD STAPLES ON 10-INCH CENTERS ON EACH SIDE OF THE WATTLE TO PREVENT FLOATATION.
- 4. WATTLES SHOULD NOT BE USED IN HARD BOTTOM CHANNELS.
- 5. FOR USE IN LOW TO MEDIUM FLOW CONDITIONS.

STRAW WATTLE CHECK DAM

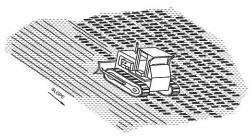

- USE DOZER TRACKS TO CREATE GROOVES PERPENDICULAR TO THE SLOPE, GROOVES WILL CATCH SEED, FERTILIZER, MULCH, RAINFALL AND DECREASE SEDIMENT IN RUNOFF.
- ALL SLOPES 3.1 OR STEEPER SHALL BE "TRACK-WALKED" PRIOR TO ANY TEMPORARY SEEDING OR AFTER PLACEMENT OF FINAL TOPSOIL LAYER IN AREAS TO BE HYDRO-SEEDED.

TRACK WALKING

11 W. COURT SQUARE P.O. BOX 278 ANDALUSIA, AL 36420


(334) 222-9431 H

DETAILS
ENTRANCE FACILITY - UTILITIES PLAN
FOR BALDWIN COUNTY
SUMMERDALE, AL MAGNOLIA

DRAFT

AS SHOW Mar-23


PROJECT NO:R SHEET NO. C-802

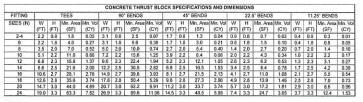


NOTES:


- BASED ON 200 PSISTATIC PRESSURE PLUS AWWA WATER HAWMER ALLOWANCE ASSUMING 1,500 PSF BEARING CAPACITY OF SOLL COORDINATE ACTUAL DIVENSIONS WITH ENGINEER PRIOR TO INSTALLATION.
- ACTUAL DIMENSIONS WITH ENGINEER PRIOR TO INSTALLATION.

 2. ALL BEARING SURFACES TO BE CARRIED TO UNDISTURBED GROUND.
- THRUST BLOCKS TO BE USED AT ALL LINES OPERATING UNDER PRESSURE.
- THESE DETAILS IN NO WAY LIMIT THE SIZE OR LOCATION OF ADDITIONAL BLOCKING WHEN REQUESTED BY THE ENGINEER, OR IF DEEMED NECESSARY BY CONTRACTOR.
- 5. DEPTH FROM GROUND SURFACE TO TOP OF BLOCKING SHALL BE GREATER THAN HEIGHT OF BLOCKING.
- ALL FITTINGS SHALL BE WRAPPED WITH VISQUEEN OR POLYWRAP BEFORE CONCRETE IS PLACED, TO PREVENT CORROSION OR BONDING OF THE CONCRETE TO THE BOLTS, FITTINGS, OR PIPE.
- 7. CONTRACTOR MAY BE ALLOWED TO INSTALL MECHANICAL JOINT RESTRAINTS INSTEAD OF THRUST BLOCKS WITH APPROVAL BY THE ENGINEER.

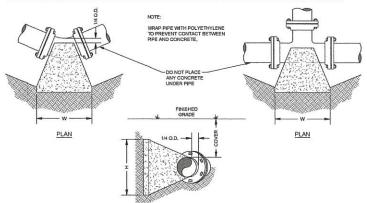


TYPICAL HORIZONTAL THRUST BLOCK DETAILS
NOT TO SCALE

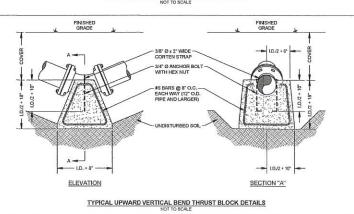

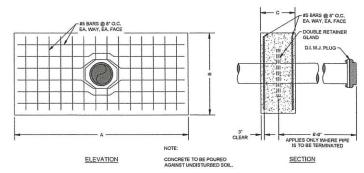


PIPE DIA. A B C
4"-6" 6"-0" MIN. 3"-0" MIN. 1"-6"
10" 6.12" 6"-0" MIN. 4"-0" MIN. 1"-6"
16" - 24" 10"-0" MIN. 5"-0" MIN. 2"-0"

TYPICAL LONGITUDINAL ANCHOR DETAIL NOT TO SCALE

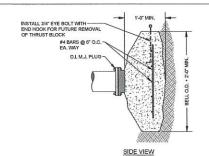

PIPE TERMINATION THRUST BLOCK DETAIL

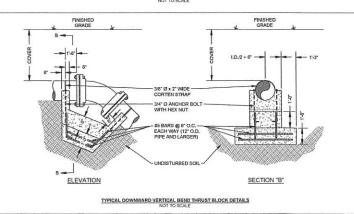

11 W. COURT SQUARE P.O. BOX 278 ANDALUSIA, AL 36420 PH: (334) 222-9431

DETAILS
MAGNOLIA ENTRANCE FACILITY - UTILITIES PLAN
FOR BALDWIN COUNTY
SUMMERDALE, AL

DRAFT

SCALE: A5 SHOWN
DATE: Mar-23
REVISED
PROJECT NO. NOTPUZINGS
SHEET NO. C-803

MAGNOLIA ENTRANCE FACILITY - SCALEHOUSE FOR BALDWIN COUNTY

APPROXIMATE PROJECT LOCATION

MAGNOLIA LANDFILL SUMMERDALE, AL March 2023



BALDWIN COUNTY COMMISSION

DISTRICT 1 HONORABLE JAMES E. (JEB) BALL

> DISTRICT 2 HONORABLE JOE DAVIS, III

DISTRICT 3 HONORABLE BILLIE JO UNDERWOOD

DISTRICT 4 HONORABLE CHARLES F. (SKIP) GRUBER

> SOLID WASTE DIRECTOR TERRI GRAHAM

> > DEPUTY DIRECTOR ED FOX

INDEX TO SHEETS Sheet Number TITLE SHEET G-102 NOTES & LEGEND C-301 SITE LAYOUT & GRADING PLAN C-501 OFFICE FLOORPLAN & SPECIFICATIONS

LOCATION MAP

SITE ADDRESS:

MAGNOLIA LANDFILL 15140 CO RD 49 SUMMERDALE, AL 36580





ANDALUSIA, AL GADSDEN, AUBURN, AL HOOVER, DOTHAN, AL HUNTSVILLE

CDG PROJECT NUMBER: R079321638

PROJECT NOTES

- COG INC. (COG) SHALL NOT HAVE ALITHORITY OVER THE SITE OR BUILDING CONTRACTOR'S WORK OR SILITIES, COG IS NOT RESPONSIBLE FOR SITE SAFETY PROCEDURES OR METHODS OF CONSTRUCTION.
- ALL EXISTING IMPROVEMENTS SHALL REMAIN UNLESS SPECIFICALLY NOTED HEREON, UPON FIELD VERIFICATION, IF ANY OF THESE IMPROVEMENTS CONFLICT WITH PROPOSED DESIGN, CONSULT WITH CDG PRIOR TO REMOVAL.
- 3. COG INC. (COG) SHALL NOT BE RESPONSIBLE FOR EPROPS AND OMISSIONS RESILITING FROM DESIGN MODIFICATIONS MADE AFTER THE RECORD DATE OF THESE FLANS SHOWN HEREON, ADJUSTMENTS TO THESE PLANS MAY BE MECESSARY. FOR OWER REQUEST, THE CONTRACTOR IS REPROPSIBLE FOR THE FURNOMES OF A CONTRACTOR'S LICENSE AND BUSINESS LICENSE FROM THE CITY AND / OR COUNTY AS APPLICABLE. AS WELL AS: ALL OTHER LICENSES AND PERMITS REQUIRED FOR COMPLETION OF THE WORK
- 4. EXCEPT FOR EMERGENCY WORK, WORK SHALL NOT BE PERFORMED ON SATURDAY, SUNDAY, OR ANY LEGAL HOLIDAY WITHOUT APPROVAL OF THE COMMER AND ENGINEER WORK SHALL COCUR RURING REASONABLE DAY-TIME HOURE REQUESTS FOR CENTRICISE FROM HIS SCHEDULE SHALL BE MADE TO THE EMBRIEER OF A CASESHY-CASE BASISS A MEMILIM OF 72 HOURS PRIOR, EXCEPT FOR EMERGENCIES, IN WHICH CASE NO SUCH APPROVAL IS REQUIRED.
- THE CONTRACTOR SHALL AT A MINIMUM, COMPLETE SATISFACTORY ROUGH GRADING, ROCK REMOVAL, AND
- 6. THE CONTRACTOR IS RESPONSIBLE FOR DOCUMENTATION OF EXISTING CONDITIONS PRESENT WITHIN AND THE COMMODITOR ENERGY/DISELE, PROJECT/DISELE POR THE COMMODITOR OF ENGINEER OF THE PROPERTY OF
- THE CONTRACTOR SHALL BE RESPONSIBLE FOR ANY DAMAGE CAUSED BY HIS ACTIVITIES IN THE PROLECT AREA. WHETHER ON HEALE OF PRIVATE PROPERTY, DAMAGE SHALL BE REPROLECT DEPRICATION TRUCTRIC ACCIDITIONS OR BETTER, AND TO THE SHIS SACTION OF THE BYGINEER AND LAND OWNERIGS, REPAIRS SHALL BE MADE AT THE CONTRACTORS SUPERMIS.
- THE CONTRACTOR SHALL COORDINATE ALL CONSTRUCTION ACTIVITY IN THE PROJECT AREA WITH THE COUNTY, CITY, AND STATE, AS APPLICABLE.
- THE CONTRACTOR SHALL TAKE NECESSARY PRECAUTIONS AS TO NOT DISTURB PROPERTY CORNER/ROW MARKERS
 AND BENCHMARKS. IT SHALL BE THE CONTRACTORS RESPONSIBILITY, INCLUDING ANY REQUIRED SURVEYING, TO
 REPLACE ANY DISTURBED MARKERS ANDORS MODIJUENTS.
- WHERE APPLICABLE, THE CONTRACTOR IS RESPONSIBLE FOR PROVIDING AND MAINTAINING TRAFFIC CONTROL IN ACCORDANCE WITH THE REQUIREMENTS OF PART 6 OF THE MUTCO, LATEST EXTRON, AND IN ACCORDANCE WITH ANY ATTACHED TRAFFIC CONTROL PLAN.
- 11. UNLESS APPROVED IN ADVANCE BY THE ENGINEER THE CONTRACTOR SHALL MAINTAIN ACCESS FOR THE TRAVELING PUBLIC, BURROEHCY, AND CHOICU, VEHICLES AT ALL TIMES ALONS ALL CITY, COUNTY, AND STATE RIGHTS OF WAY, IF ARDAD LOSSIES BLALLOWS IT THE CONTRACTOR SHALL BE RESPOSIBLE FOR COORDINATING SUCH CLOSURES WITH CITY, COUNTY, AND OR STATE AGENCIES, AND EMERGENCY AGENCIES. IN ACCORDANCE WITH THOSE PARTESS REQUIREMENTS.
- 12. DRINEWAYS WHICH MAY HAVE BEEN OUT OR OTHERWISE DAMAGED DURING THE CONSTRUCTION ACTIVITIES SHALL BE MANITANED IN A USABLE CONDITION FOR THE DURATION OF THE PROJECT. THE CONTRACTOR SHALL MAKE A REASONABLE EFFORT TO RE-OPEN DRIVEWAYS BE SOON A POSSIBLE. IN NO CASE SHALL DRIVEWAYS BE CLOSED
- 13. ALL EQUIPMENT SHALL BE PARKED AND ALL MATERIALS SHALL BE STORED AT A LOCATION OUTSIDE THE PUBLIC RIGHT OF WAY AT A LOCATION OF THE CONTRACTOR'S CHOOSING, PRICE TO PIRLA PAYMENT, THE CONTRACTOR SHALL PROVIDE WRITTEN NOTICE FROM THE COMES OF SUCH PARKING AND STORAGE REAGIS, THAT THE AREA(S) HAVE BEEN RESTORED TO LAND OWNERS SATISFACTION, AND THE TERMS ASSOCIATED WITH ANY SUCH ARRANGEMENTS HAVE BEEN ASSISTED.
- 14. EXISTING DRAINAGE SYSTEMS SHALL REMAIN FULLY OPEN THROUGHOUT THE PROJECT DURATION, ANY DISTURBANCE OR DAMAGE TO EXISTING DRAINAGE SYSTEMS AND STRUCTURES SHALL BE REPAIRED OR REPLACED TO THE SATISFACTION OF THE ENGINEER AND THE CITY, COUNTY, AND/OR STATE AT NO ADDITIONAL COST TO THE OWNER.
- 16. EXCEPT FOR WHERE NEEP FAMES STATE OF HERMASE, OR THE PLANS REQUIRE TEMPORARY CONSTRUCTION FEBRORS OF BENISTALED EXISTING FEBROSS SHOULD FEBROARD BE RECORDED OF OTHERWISE DAMAGED DURING THE CONSTRUCTION ACTIVITIES. REMOVED, RELOCATED, OR DAMAGED FRICES SHALL BE REPLACED TO THE ASSISTANCIAN OF THE EMBERS AND LAND OWNERS AT NO ACCORDINAL COST OF THE OWNER.
- RESIDENTS AND BUSINESS HALL NOT BE LEFT WITHOUT MAL. SERVICE. IF A MALBOX MUST BE MOVED TO
 DESCRIPTION OF THE PROPERTY OF THE PROPERTY AND DISTRICTION THE DOCATED AS DESCRIPTION
 FOR MALBOX PACKEDIST.
- JOB SITE SHALL BE CLEANED ON A DAILY BASIS. THE CONTRACTOR SHALL RESTORE ALL AREAS, WHETHER PUBLIC OR PRIVATE, AS SOON AS PRACTICABLE FOLLOWING COMPLETION OF PARTICULAR CONSTRUCTION ACTIVITIES.
- 18. THE CONTRACTOR SHALL REPAIR ALL SCICKLATES AREAS, BECKELLE EMBANGERS TRENCHES AND DITCHES WHICH THE WARE SHILLDAN TO ACCOTTANCE OF THE PROJECT AND THROUGHOUT THE WARRANITY PERIOD, ALL SUCH AREAS SHALL BE RESTORED TO PRESCONSTRUCTION CONTOURS.
- 19. UNLESS NOTED ELSEWHERE, NO ADDITIONAL PAYMENT SHALL BE MADE FOR ROCK EXCAVATION AND REMOVAL UNLESS ROLLED ESPRÉNEIX. NO DOUBLINAR TAYMENT SHILL BUT MODE FOR POOR EXCAVATION AND TREMOVED BEDERRA MAY MADE PURIT OWN IN PRISABILATION AS TO THE AROUND AND THE ARROY OF THE AROUND ALL COSTS FOR ROCK EXCAVATION SHILL BE CONSIDERED TO HAVE BEEN INVIDED IN THE WARRUNG PAY THE WARR THE PRISABILITY OF THE THE AROUND A THE PRISABILITY OF THE BUDGET AND CONTRACTOR AND SHILL NOT BE SEEN THE BUSGET OF THE PROPRIED THE CONTRIBUTE OF THE BUDGET AND CONTRACTOR AND SHILL NOT BE SEEN THE BUSGET OF THE PROPRIED THE THE PROPRIED THE PROPRIED
- 28. THE CONTRICTOR IR RESPONSIBLE FOR MAINTAINING ALL GRASSED AREA 6.4 IT IS EVENINE UNTIL TANK.
 ACCEPTANCE AND INTENDED HIT THE WARRANT PRICED, MAINTENANCE OF GRASSED ANGLES SHALL INCLUDE
 RE-GRADING, RE-FERILDATION, RE-SEEDING, WATERING, AND ANY OTHER WORK AS REQUIRED. TO PRODUCE AND
 KEEP THE GRESS IN A CONCIDENT ACCEPTABLE TO THE EXPINIERS AND AND CONTROL.

- EXISTING UTILITIES ARE DEPICTED BASED ON FORM (IN "QUALITY LEVELS" DEFREADA FOLLOMS.
 A UNAUTY LEVELS A FORDIOTAL NA MOVERTION, LOCATION OBTAINED BY ACTUAL ENPOSINE AND MEASUREMENT
 OF THE UTILITY AT A SPECIFIC POINT.
 I. QUALITY LEVEL APPROXIMATE LOCATION OBTAINED FROM SURFACE GEOPHYSICAL METHODS. NO DEPTH
 INFORMATION RECULCED.
 C. QUALITY LEVEL APPROXIMATE LOCATION DERVEYED AND PLOTTED BASED ON VISIBLE ABOVE-GROUND UTILITY
- d DIALITY LEVEL D INFORMATION DERIVED FROM EXISTING RECORDS AND/OR ORAL RECOULECTIONS.
- 2. ALL UTILITIES ARE DEPICTED AT "QUALITY LEVEL B" UNILESS INDICATED OTHERWISE AND LABELED AS "QL-C" OR "QL-D".
- ANY "QUALITY LEVEL A" ELEVATIONS PROVIDED ARE FROM THE TOP OF THE UTILITY AT THE APPROXIMATE LOCATION SHOWN, URLESS OTHERWISE NOTED.

- NEITHER THE OWNER NOR THE ENGINEER MAKES ANY EXPRESSED OR IMPLIED GUARANTEE OF THE ACCURACY OF UTILITIES SHOWN OR ANY GUARANTEE THAT ALL UTILITIES LOCATED WITHIN THE CONSTRUCTION AREA ARE SHOWN HERBIN.
- THE CONTRACTOR SHALL CALL ALABAMA ONE CALL AT 811 FOR UTILITY MARKING PRIOR TO COMMENCING CONSTRUCTION. IT SHALL BE THE CONTRACTOR'S RESPONSIBILITY TO DETERMINE THE EXACT LOCATION OF ALL UNDERGROUND UTILITIES SEFORE COMMENCING WORK, ANY DAMAGE TO EXISTING UTILITIES SHALL BE REPAIRED AT THE CONTRACTOR DUPIES.
- 6. THE CONTRACTOR SHALL COORDINATE ALL WORK ADJACENT TO EXISTING UTILITY POLES AND GUY WISES WITH THE LOCAL POWER COMPAINT. THE CONTRACTOR SHALL CONTRACT THE LOCAL POWER COMPAINT TO HOLD SAID UTILITY POLESIGUY WIRES DURING SORING OR OPEN CUT OPERATIONS. THE COST OF THIS WORK SHALL BE CONSIDERED INCIDENTAL TO THE PROJECT AND NO ADDITIONAL PAYMENT WILL BE MODE.
- THE CONTRACTOR SHALL COORDINATE ALL TIE-INS, CONNECTIONS, OUTAGES, AND VALVING OPERATIONS WITH THE UTILITY OWNER. THE CONTRACTOR SHALL GIVE 72 HOURS NOTICE TO THE UTILITY OWNER OF WHEN SUCH OPERATIONS ARE TO TAKE FLACE.
- 8. THE CONTRACTOR SHALL COORDINATE WITH AND PROVIDE REASONABLE NOTICE TO RESIDENTS AND BUSINESSES. OF UTILITY SERVICE OUTAGES PRIOR TO BEGINNING SUCH OPERATIONS, NO RESIDENT OR BUSINESS SHALL BE LEFT WITH OUT SERVICE OVERNIGHT,
- ALL NEW MAINS SHALL BE INSTALLED AT LEAST 36" BELOW THE SURFACE. AT LOCATIONS WHERE THE REQUIR MAIN BY TO CROSS AN EXISTING UTILITY. THE MAIN SHALL BE FLACED A MINIMUM OF 24" ABOVE OR BELOW THE EXISTING MAIN, BUT NO LESS THAN 30" BELOW THE SURFACE.
- 18. RECORD PRIVATING OF ALL MAIN AND ENTYCE LIKE INSTALLATIONS SHALL BE PROVIDED BY THE COMPRICTOR. THESE DRAWNES SHALL INCLUDE HORIZONFAL LOCATIONS OF LIKES AND VALVES. AS AND LATES AND VALVES. AND VALVES AND VALLES AND VALVES AND VALVE AND
- CONTRACTOR SHALL BE RESPONSIBLE FOR COORDINATING ALL UTILITY LOCATIONS WITH THE LOCAL UTILITIES.
 CONTACT WITH EACH UTILITY SHOULD BE MADE BEFORE ANY CONSTRUCTION BEGINS ON THIS PROJECT.
- COGRDINATE ALL ELETRICAL IMPROVEMENTS TO AVOID CONFLICT WITH PROPOSED DESIGN AND EXISTING UTILITIES, ANGINEER SHALL APPROVE FINAL POLE LOCATIONS.

- IT IS CONTRACTOR'S RESPONSIBILITY TO PROVIDE CONSTRUCTION LAYOUT AND GRADE STAKING. CDG WILL PROVIDE ELECTRONIC DESIGN FILES IN DWG FORMAT.
- IT IS THE CONTRACTOR'S RESPONSIBILITY TO PROTECT ALL BENCHMARKS AND PROPERTY CORNERS, ANY REPLACEMENT WILL BE AT THE CONTRACTOR'S EXPENSE.
- IT IS THE RESPONSIBILITY OF THE CONTRACTOR TO OBTAIN ALL NECESSARY PERMITS REQUIRED TO CONSTRUCT
 THIS PROJECT. ALL PERMITS MUST BE IN-HAND PRIOR TO CONSTRUCTION.
- ALL ADA ACCESSIBLE ROUTES, PARKING, RAMPS, CROSSWALKS, SIGNS, SYMBOLS, AND PAINTED ISLANDS MUST CONFORM TO THE LATEST ADA REQUIREMENTS.
- 5. TOPOGRAPHICAL (HORIZONTAL ONLY) AND CONTROL (HORICNTAL AND VERTICAL) SURVEYS PERFORMED BY CDG.
- 6. ALL DIMENSIONS ARE TO BACK OF CURB UNLESS OTHERWISE NOTED.
- NOTIFY ENGINEER IMMEDIATELY IF ANY ERRORS AND OMISSIONS ARE FOUND.
- HORIZONTAL AND VERTICAL DATUMS USED IN DESIGN ARE NAD83 AL STATE PLANE WEST AND NAVD88
- 9. NO GRADING OFF-SITE OR IN ANY ROAD RIGHT-OF-WAY WITHOUT PROPER APPROVALS
- ALL GRADING ADJACENT TO EXISTING OR PROPOSED BUILDINGS SHALL BE SLOPED AWAY FROM THE STRUCTURES.
 THE CONTRACTOR SHALL ASSURE POSITIVE DRAINAGE AWAY FROM THE STRUCTURES. NOTIFY COG OF ANY DISCREPANCIES
- PROPOSED GRADES INDICATED ON THIS PLAN ARE TO FINISH GRADE, THE CONTRACTOR SHALL MAKE SUBGRADE ADJUSTMENTS FOR TOPSOIL, PAVEMENT, BUILDING PAD, ETC.

- SITE EROSION CONTROL MEASURES SHALL BE IN ACCORDANCE WITH ALL FEDERAL, STATE AND LOCAL LAWS, CODES, AND REGULATIONS.
- 3. ALL EROSION CONTROL MEASURES ARE TO BE MAINTAINED UNTIL PROJECT COMPLETION.
- THE CONTRACTOR SHALL PROVIDE A BMP PLAN FOR APPROVAL BY THE ENGINEER PRIOR TO THE BEGINNING OF CONSTRUCTION.
- THE CONTRACTOR IS RESPONSIBLE FOR PROPERLY INSTALLING AND MAINTAINING SUFFICIENT EROSION CONTROL MEASURES AS MAY BE REQUIRED TO PREVENT SEDIMENT FROM DISCHARGING FROM THE SITE, AND IN COMPLIANCE WITH ANY PERMITS AND CEMPP
- 6, ALL DISTURBED AREAS THAT DO NOT RECEIVE WORK FOR 13-DAYS SHALL BE TEMPORARY SEEDED AND MULCHED,

	LEGEND	
	EXISTING	PROPOSED
	UTILITIES	
POWER POLE	Ó	in the second
LIGHT POLE	-0-	-8-
TELEPHONE POLE	0	
ANCHOR	Δ	À
STUB (POWER)	Ö	10
STUB (TELEPHONE)	-	•
ELECTRIC METER	EM .	0
BURIED ELECTRIC CABLE		
OVERHEAD ELECTRIC CABLE		
ELECTRIC MANHOLE	0	
ELECTRIC TRANSFORMER		
TOWER	×	100
TELEPHONE PEDESTAL	(f)	0
BURED TELEPHONE CABLE	BTCBTC	BIC BIC
OVERHEAD TELEPHONE CABLE	OICOIC	
BURIED FIBER OPTIC		
TELEPHONE MANHOLE	(TMA)	TWE
WATER MAIN		Link
WATER VALVE		A
FIRE HYDRANT		<u> </u>
WATER METER		<u> </u>
GAS MAIN	N	<u> </u>
GAS WALVE		
	<u> </u>	
GAS REGULATOR		<u> </u>
SANITARY SEWER		
FORCE MAIN	fufu	FMFM
SEWER MANHOLE	3	9
AIR/VACUUM RELEASE VALVE	ÁV	
CLEANOUT	0	0
	DRAINAGE	
DITCH LINE		
STORM MANHOLE	(1)	•
STORM PIPE		STMSTM
	MISC	
SIGN		
MAILBOX	(AUE)	(MB)
A/C UNIT	A	A
BORING LOCATION OR TEST PIT		•
WELL	((V)	(0)
MONITORING WELL	(M)	69
FLAG POLE		
SPOTELEVATION	According to the control of the cont	
FOUND IRON PIN	•	
SET IRON PIN		
CONCRETE MARKER	59	69
BENCHMARK	69	
TREES	(-)	
PROPERTY LINE		
RIGHT-OF-WAY	ROWROW-	
CHAIN LINK FENCE		
WOOD FENCE		
BARBED WIRE FENCE		xxx
HOG WIRE FENCE	(1)(1)(1)(1)	_ (i) _ (i) _ (i) _
1.00 THAT PEROL	EROSION CONTROL	w w _
SILT FENCE	ENOSION CONTROL	
OIL1 FEINGE	GRADING	
COURSE IN LIVE ION	GRADING	
CONTOUR MAJOR		100
CONTOUR MINOR		99

	EXISTING	REQUIRED		EXISTING	REQUIRED
ASPHALT			RIP-RAP		
CONCRETE			WATER	3333	3030
GRAVEL.			WOOD DECK		
AWNING					





11 W. COURT 8 P.O. BOX ANDALUSIA, A F

EHOUSE ENTRANCE FACILITY - SCAL FOR BALDWIN COUNTY SUMMERDALE, AL GEND Ш య ES NOT MAGNOL


DRAFT

SCALE:	AS SHOWN
DATE:	Mar-23
RE	VISED
PROJECT	NO:R079321938
SHEET NO	. C-102

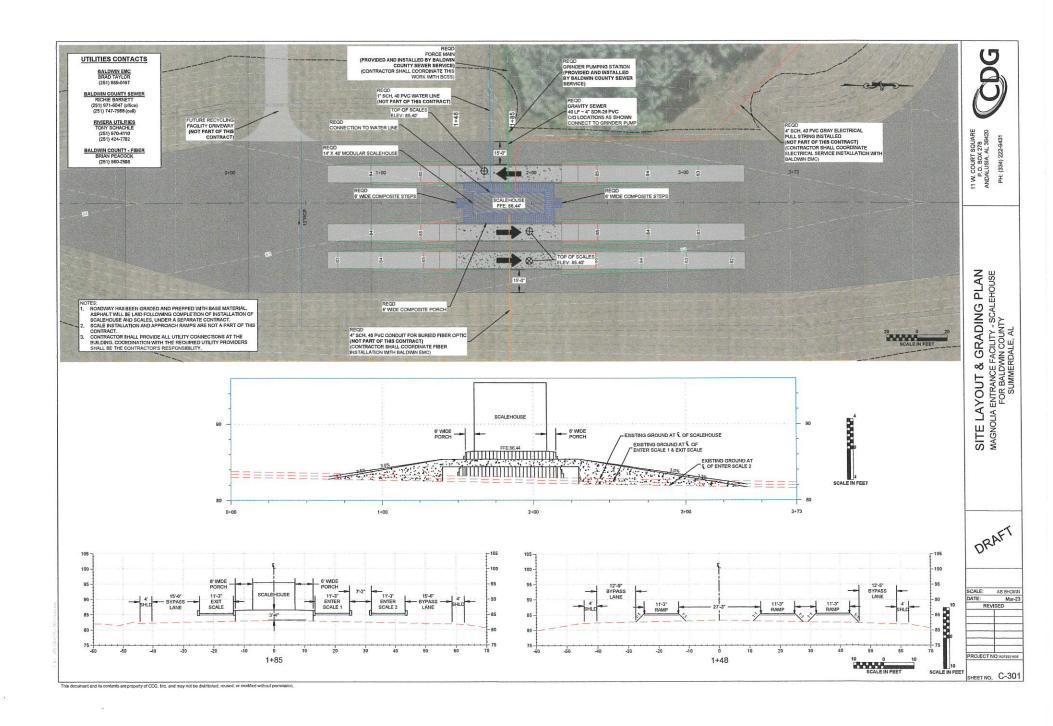

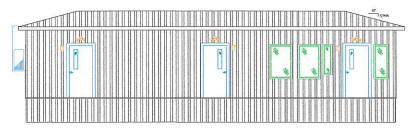

LEFT ELEVATION

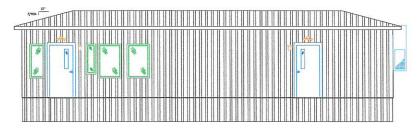

RIGHT ELEVATION

GENERAL:

14' x 48' Scale office 672 square feet Business occupancy Alabama label, ANHC approval Wind load: Zone II, 100 MPH Vult Roof load: 20 PSF

FRAME:

14' x 45' perimeter frame with 12" I beam Removable hitch 8" steel floor joists at 16", welded inside of frame (2) 5000¢ brake axtee with 14 ply tires (2) 6000¢ idler axtee with 14 ply tires

FLOOR:

Woven nylon impregnated bottom board
R-30 Unfaced insulation
Two layers 5/8" torgue and groove plyvood floor decking
LVT plank, 20 mill, choice of factory colors
4" rubber base core throughout with pre-molded inside & outside

No floor covering or base cove in storage room

WALLS:

VYALLOS:
Single top and single bottom steel track
2" x 4" steel joists @ 16" on center, 6" 6" interior wall
R-13 Unfaced instantion interior walls
2" x 6" steel joists @ 16" on center, 6" 6" exterior wall
R-21 Kraft faced exterior walls %" gypsum, tape/mud/paint ove

solid birch slab doers in bronze Redi-frame

(2) Door closers (2) Privacy lever looks

ROOF:

RODE:
Gable roof with hip on front end, 3:12 pitch
8° overhang on all sides
25 gauge Hi-lib steel roofing
Steel trusses at 16° on center
56° phywood decking
2° x 2° suspended ceiling at 6° above finished floor
R-38 Unfaced insulation held up with netting

PLUMBING:

Single ADA restrooms
PEX supply lines
PUC waste, stub out below bottom board
 Wall hung sinks with mirror in stainless steel frame, Bobrick

or equal

or equal
(3) (2) Vinyl anti scald cover for trap & supply
(2) ADA tollet with Sloan flush valve, 3 greb ba
(1) 20 gallon water heater. Lo-Bey located und
(1) Mop sink with legs and faucet located in sto (a) (2) Virily and scald cover for trap & supply
(b) ADA folds this Shan flash 1-490. 3 grab hars
(b) 20 gallion water heater, Lo-Bey located under the cabinet
(b) Mop sink with logs and fause located in storage room
(b) Couble stainless store sink with gooonneck faucet
(c) Stainless steel local paper disponencer, B, 264
(c) Stainless steel paper towel disponence, B, 279
(d) Stainless steel paper towel disponence, B, 279
(d) Stainless steel soap disponence, B, 2111

CABINETS:

12 Linear feet of high pressure laminate base cabinets and

counter top 9 Linear feet of HPL overhead cabinets

9 Linear feet of HPL overhead cabons
13 Linear feet of HPL desktop with (4) grommets
13 Linear feet of HPL writing ledge at 42" AFF on lobby side
13 Linear feet of HPL writing ledge at 35" AFF on office side
(1) 4 x 4 plywood phone board with fire retardant paint
(1) Semi rocessed fire extinguisher cabinet with 10# fire

extinguisher

ELECTRICAL:

Tgrid

Plenum walt

EXTERIOR: 5/8" plywood sheathing, full wrap Moisture resistant house wrap, full perimeter

26 Gauge Hi-Rib steel siding and trim
(4) 36" x 48" fixed windows in bronze aluminum frame, Low E,

30" x 48" fixed windows in bronze aluminum frame, Low E.

insulated
(2) 24" x 48" fixed windows in bronze aluminum frame, Low E,

(2) 15" x 42" fixed windows in bronze aluminum frame, Low E,

(2) 15 x 4.2 loces wholeves in pronze assiminum frame, Low to insulated (16) 2º faux blinds (5) 36° x 80° Stoel doors in steel jamb (3) 6° x 30° when mesh view blocks; storage room & exterior

bathroom doors are blank
(5) closers, keyed levers/deadboll (all doors keyed alike)
Steel skirting or equivalent

Copper tomock:

(1) 125 AMP, single phase
Copper tomoc witing with MC in ceiling cavity only
Copper tomoc witing with MC in ceiling cavity only
(2) GFC in ceptarials

(3) GFC in ceptarials

(4) Delicated receptacle for the refrigerator

(5) Exterior GFI with locking cover

(1) Heat tape receptacle under the building

(6) 2 x 4 junction boxes at 16° above finished floor with conduit

stub outs

(2) Exit/emergency combo with remote heads

(8) 2' x 4' LED flat panel lights, 48 watt, 5070 lumens, 4000K in

(6) Occupancy sensors
(5) LED porch lights with photocell (18W)

HVAC:

3 ton wall hung HVAC units with 10kw heat, dehumidification (11 EER)
 7-day programmable thermostat with humidity control


Galvanized metal duct supply and return (2) 100 CFM vent fans

DECKING & STEPS:


6 Wide Wood-Plastic Composite Decking (Trex Enhance or Approved Equal) installed per Manufacturer's Recommendations 900 square feel 12" Joist Spacing

Color to be selected by owner

(2) 6' Wide Wood-Plastic Composite Steps (Trex Enhance or

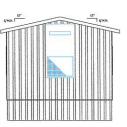

REAR ELEVATION

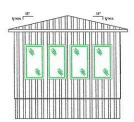

FRONT ELEVATION

FOUNDATION:

Poured footers required per approved drawings by the factory

Poured footers required per opproved drawings by the factory engineer.

All footers shall be reinforced and inspected by the Alabama Mandiectured Housing Comerisation and Geolechnica Rabama Mandiectured Housing Comerisation and Geolechnica Rabama and Seal State (prinders, tested weekly after the pour or the centractor must wait 28 days per State code before setting the building, Oreach the cylinder brotast at before sealing line designing. Once the cythical orders at 3,000 per, the building may be set upon the footers. After the building is set, all piers must be mortared with cement in the coffs of the piers. There shall be a 3/8" weld plate embedded into the top of each

piers.
The I beam frame of the building shall be welded to the weld plate on each pier.

SITE NOTES:


The site pad must be crowned or sloped so that storm water will not pond or flow under the
The site must have a 2000 lb. minimum soil compaction

COMMUNICATION:

Number and locations to be determined.
Contractor to provide central location for access to all FCP internal connections for the purpose of connecting to external network and phone lines.
Cable drops for computer, phone and eloctrical systems are to be sufficiently accessable to allow future repairs, maintenance

surricently accessore to agov titure repairs, maintent and expansion. Ethernet and phone outlets (number and type outlet to be determined) are to be installed near electrical outlets, preferably within three feet.

(2) o Ware Wood-Hastic Composite Steps (Tres Enhance o Approved Equal) installed per Manufacturer's Recommendations 66 linear feet of Trex Transcend railing with Cocktail Rail & Round Aluminum Balusters (or Approved Equal)

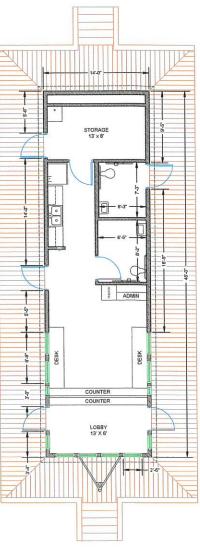



11 W. COURT SQUARE P.O. BOX 278 ANDALUSIA, AL 38420 PH: (334) 222-9431

FLOORPLAN & SPECIFICATIONS
NOLIA ENTRANCE FACILITY - SCALEHOUSE
FOR BALDWIN COUNTY
SUMMERDALE, AL OFFICE FLOOM

DRAFT

SCALE: AS SHOWN DATE: Mar-23 PROJECT NO: 8

SHEET NO. C-501

This document and its contents are property of CDG, Inc. and may not be distributed, reused, or modified without permission