

MACBRIDE LANDFILL SCALEHOUSE

FOR BALDWIN COUNTY COMMISSION

R079319035 LOXLEY, ALABAMA AUGUST 2020

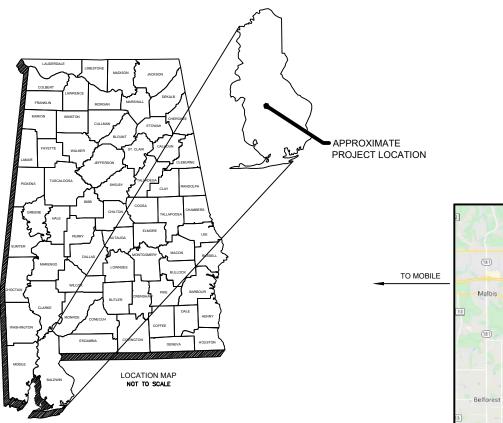

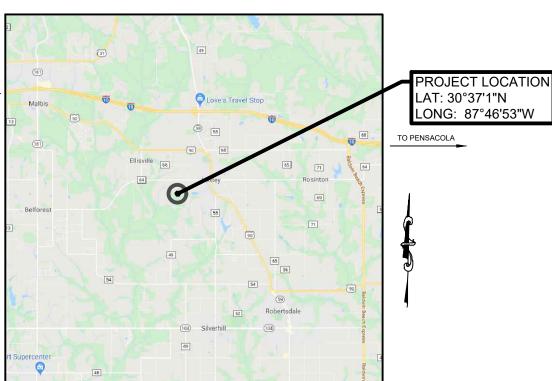

CLIENT:

BALDWIN COUNTY COMMISSION

SITE ADDRESS:

MACBRIDE LANDFILL 14200 CO RD 64 LOXLEY, AL 36551

	INDEX TO SHEETS
SHEET NUMBER	SHEET TITLE
C-100	TITLE SHEET
C-102	NOTES AND LEGEND
C-301	EXISTING CONDITIONS AND SITE CONTROL
C-302	SITE CONSTRUCTION PLAN
C-501	OFFICE FLOORPLAN AND SPECIFICATIONS
C-801	DETAILS





Engineering, Environmental, Answers,

ANDALUSIA, AL
ALBERTVILLE, AL GADSDEN, AL
AUBURN, AL HOOVER, AL
DOTHAN, AL HUNTSVILLE, AL

CDG PROJECT NUMBER: R079319035

GENERAL NOTES:

- 1. CDG ENGINEERS & ASSOCIATES, INC. (CDG) SHALL NOT HAVE AUTHORITY OVER THE SITE OR BUILDING CONTRACTOR'S WORK OR RESPONSIBILITIES. CDG IS NOT RESPONSIBLE FOR SITE SAFETY PROCEDURES OR METHODS OF CONSTRUCTION.
- 2. EXISTING MOBILE OFFICE TO REMAIN FUNCTIONAL UNTIL PROPOSED OFFICE IS COMPLETE. ALL OTHER CONSTRUCTION ACTIVITIES AND SEQUENCING SHALL BE COORDINATED WITH OWNER TO PREVENT AN ENCUMBRANCE ON DAILY OPERATIONS.
- 3. CONTRACTOR SHALL SUBMIT DETAILED BUILDING PLANS FOR APPROVAL BY OWNER THAT INCLUDES SCHEDULES FOR STYLE AND COLOR OPTIONS TO BE SELECTED

SITE NOTES: (NOT PART OF THIS CONTRACT)


- 1. IT IS THE RESPONSIBILITY OF THE CONTRACTOR TO OBTAIN ALL NECESSARY PERMITS REQUIRED TO CONSTRUCT THIS PROJECT. ALL PERMITS MUST BE IN-HAND PRIOR TO CONSTRUCTION
- 2. THE CONTRACTOR IS RESPONSIBLE FOR ANY DAMAGE TO EXISTING IMPROVEMENTS ON OR OFF SITE DUE TO THE CONSTRUCTION OF THIS PROJECT. ANY DAMAGE WILL BE REPAIRED AT THE CONTRACTOR'S
- 3. ALL EXISTING IMPROVEMENTS SHALL REMAIN UNLESS SPECIFICALLY NOTED HEREON. UPON FIELD VERIFICATION, IF ANY OF THESE IMPROVEMENTS CONFLICT WITH PROPOSED DESIGN, CONSULT WITH CDG PRIOR TO REMOVAL
- 4. TOPOGRAPHIC SURVEY FOR DESIGN WAS PERFORMED BY CDG.
- 5. IT IS CONTRACTOR'S RESPONSIBILITY TO PROVIDE CONSTRUCTION LAYOUT AND GRADE STAKING.
- 6. IT IS THE CONTRACTOR'S RESPONSIBILITY TO PROTECT ALL BENCHMARKS AND PROPERTY CORNERS. ANY REPLACEMENT WILL BE AT THE CONTRACTOR'S EXPENSE.
- 7. HORIZONTAL AND VERTICAL DATUMS USED IN DESIGN ARE NAD83, ALABAMA STATE PLANE WEST, AND NAVD88 RESPECTIVELY.
- 8. NOTIFY ENGINEER IMMEDIATELY IF ANY ERRORS AND OMISSIONS ARE FOUND DURING STAKING.
- 9. ALL PAVEMENT MARKINGS SHALL CONFORM TO MUTCD SPECIFICATIONS.
- 10. ALL TRAFFIC STRIPING ON SITE SHALL BE APPLIED IN TWO COATS MINIMUM
- 11. ALL ADA ACCESSIBLE ROUTES, PARKING, RAMPS, CROSSWALKS, SIGNS, SYMBOLS, AND PAINTED ISLANDS MUST CONFORM TO THE LATEST ADA REQUIREMENTS.
- 12. THE CONTRACTOR SHALL DESIGNATE A MATERIALS STAGING AREA AND CONSTRUCTION PARKING AREA; LOCATIONS SHALL BE COORDINATED WITH OWNER. CONTRACTOR SHALL BE RESPONSIBLE FOR UPKEEP OF THESE AREAS TO PREVENT RUTTING AND WASHING.
- 13. THE CONTRACTOR SHALL DESIGNATE A SINGLE CONCRETE WASH AREA AND COORDINATE LOCATION WITH OWNER.
- 14. CONTRACTOR SHALL MAINTAIN GRASSING UNTIL ESTABLISHED.

GRADING NOTES: (NOT PART OF THIS CONTRACT)

- PROPOSED GRADES INDICATED ON THIS PLAN ARE TO FINISH GRADE. THE CONTRACTOR SHALL MAKE SUBGRADE ADJUSTMENTS FOR TOPSOIL, PAVING, BUILDING PAD, ETC.
- 2. ALL GRADING ADJACENT TO EXISTING OR PROPOSED BUILDINGS SHALL BE SLOPED AWAY FROM THE STRUCTURES. THE CONTRACTOR SHALL ASSURE POSITIVE DRAINAGE AWAY FROM THE STRUCTURES. NOTIFY CDG OF ANY
- 3. ALL EARTHWORK ACTIVITIES AND COMPACTION TESTING SHALL BE COORDINATED AND APPROVED BY A REGISTERED GEOTECHNICAL
- 4. GEOTECHNICAL REPORT PERFORMED BY GOODWYN, MILLS, AND CAWOOD.

UTILITY NOTES:

- 1. ALL EXISTING UTILITIES SHOWN ON THESE DRAWINGS ARE APPROXIMATE AND SHALL BE FIELD VERIFIED PRIOR TO CONSTRUCTION. ANY DISCREPANCIES SHALL BE REPORTED TO CDG.
- 2. THE CONTRACTOR IS RESPONSIBLE FOR ANY DAMAGE TO EXISTING IMPROVEMENTS ON OR OFF SITE DUE TO THE CONSTRUCTION OF THIS PROJECT. ANY DAMAGE WILL BE REPAIRED AT THE CONTRACTOR'S EXPENSE.
- 3. CONTRACTOR SHALL BE RESPONSIBLE FOR ANY CONSTRUCTION STAKEOUT WORK NEEDED DURING CONSTRUCTION.

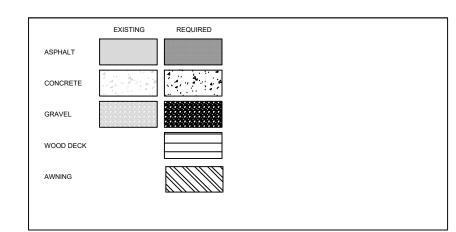

LEGEND

LEGENI	EXISTING	REQUIRED
POWER POLE	占	•
LIGHT POLE	-0-	-
ANCHOR	Δ	A
STUB (POWER)	-	-
TELEPHONE PEDESTAL	T	①
TELEPHONE MANHOLE	[ŤMĤ]	TMH
ELECTRIC METER	€M	€M
A/C UNIT	A	(A)
ELECTRIC TRANSFORMER	0	
SEWER MANHOLE	<u>s</u>	S
SEWER CLEANOUT	0	0
GAS VALVE	<u>&</u>	<u>A</u>
GAS REGULATOR	0	•
GAS METER	G	G
IRON PIN FOUND	•	
BENCH MARK	€	
CONCRETE MARKER	H	
STORM MANHOLE	(STM)	(STM)
AIR/ VACUUM VALVE	Ā	Â
WATER VALVE	\triangle	<u> </u>
FIRE HYDRANT	Θ	•
WATER METER	\boxtimes	
SIGN	_=_	_=_
MAILBOX	MB	MB
TREES	Q	
SPOT ELEVATION		•

	EXISTING		REQUIRED	
WATER LINE -	W	W		——w-
BURIED ELECTRIC -	BE	BE	BE	 BE
BURIED FIBER OPTIC -	BFO	BFO-	BFO-	
BURIED TELECOM CABLE -	BTC	BTC-	——ВТ	c
FORCEMAIN —	FM	FM	FM	FM-FM
GAS LINE —	— – – – G – – –	G	<u> —</u> в —	<u>—</u> -G
OVERHEAD ELECTRIC -	OE	OE	OE	OF
OVERHEAD TELECOM CABLE —	OTC	otc-	o	гс
SEWER LINE -	ss	ss	ss	s
PROPERTY LINE -	P	— P.——	—-₽—	—— F
RIGHT-OF-WAY —		ROW		
STORM PIPE —	STM	STM		
CHAIN LINK FENCE —		0	o	<u> </u>
WOOD FENCE —			<u> </u>	
BARBED WIRE FENCE —	X	X	x	x-
HOG WIRE FENCE -	(X)(X	(X) —	(X) — (X	
FLOW LINE -		«		
EROSION CONTROL			L I	
SILT FENCE				
TO BE REMOVED		•		ו•••
CONTOUR MAJOR —	100 —		10	0
CONTOUR MINOR —	— — - 99 —		99	<u> </u>


EAST THREE NOTCH ANDALUSIA, AL 36421 P.O. BOX 278 (36420) PH: (334) 222-9431


> MACBRIDE LANDFILL SCALEHOUSE FOR BALDWIN COUNTY COMMISSION LOXLEY, ALABAMA AND LEGEND

NOTES

SCALE: AS SHOWN 9/24/20 REVISED PROJECT NO: R079319035

SHEET NO. C-102

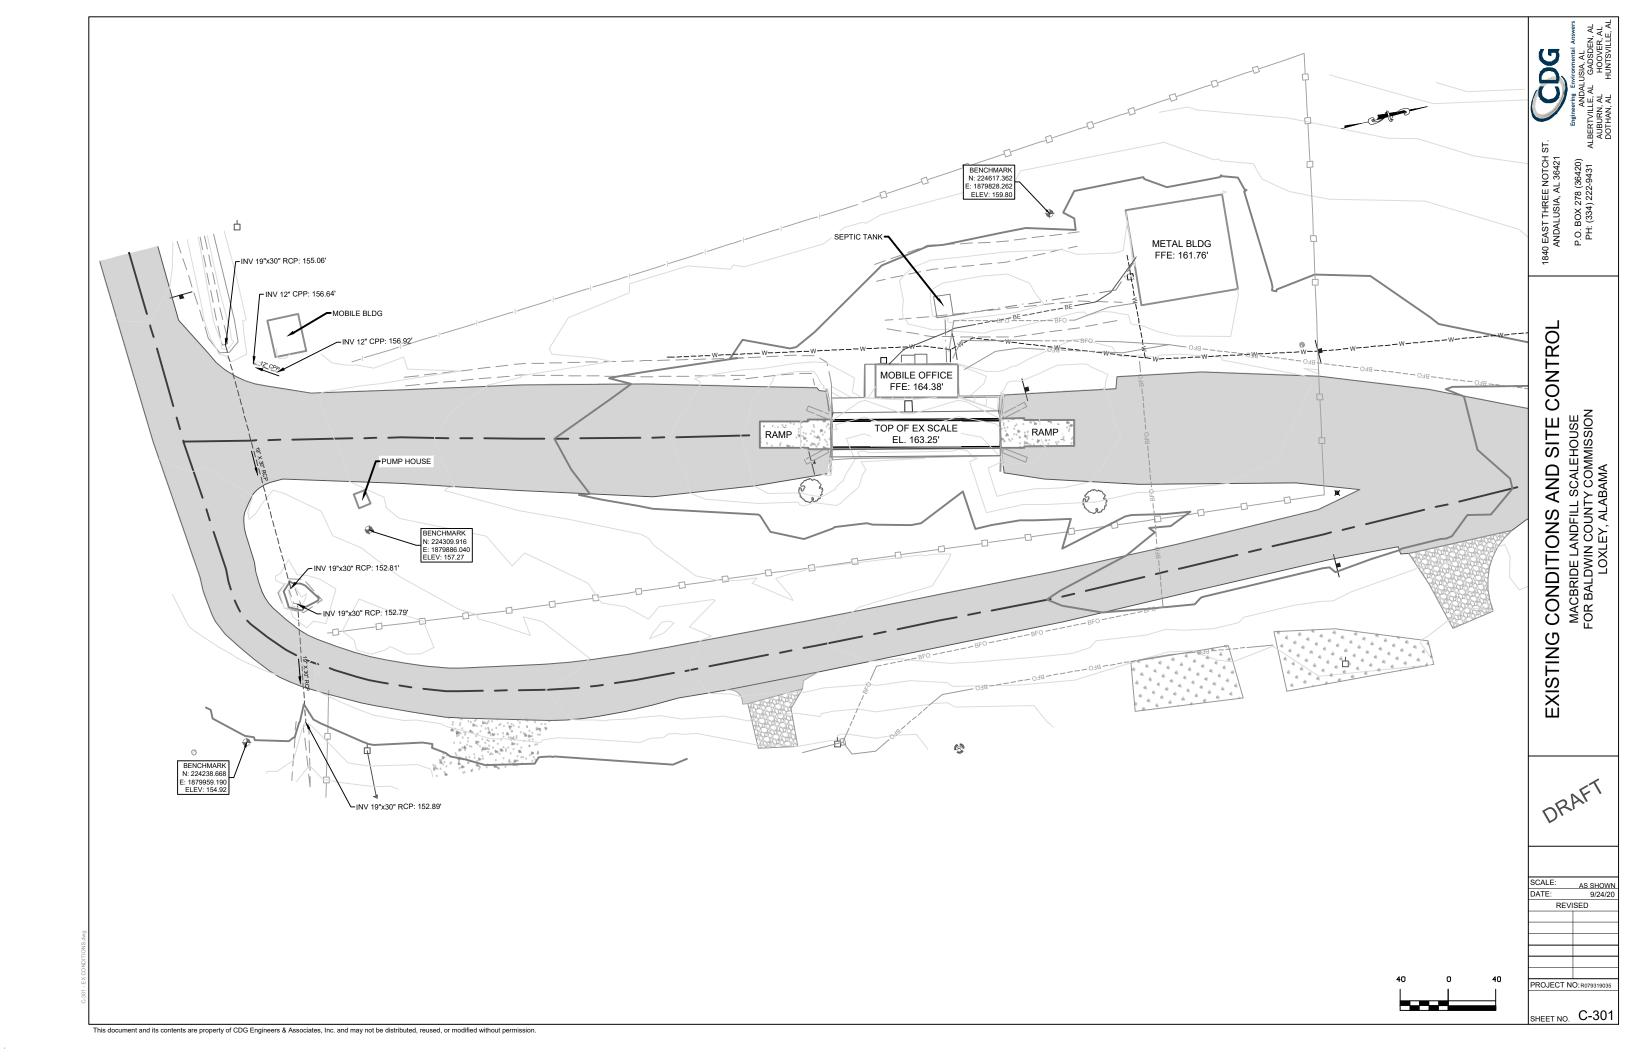

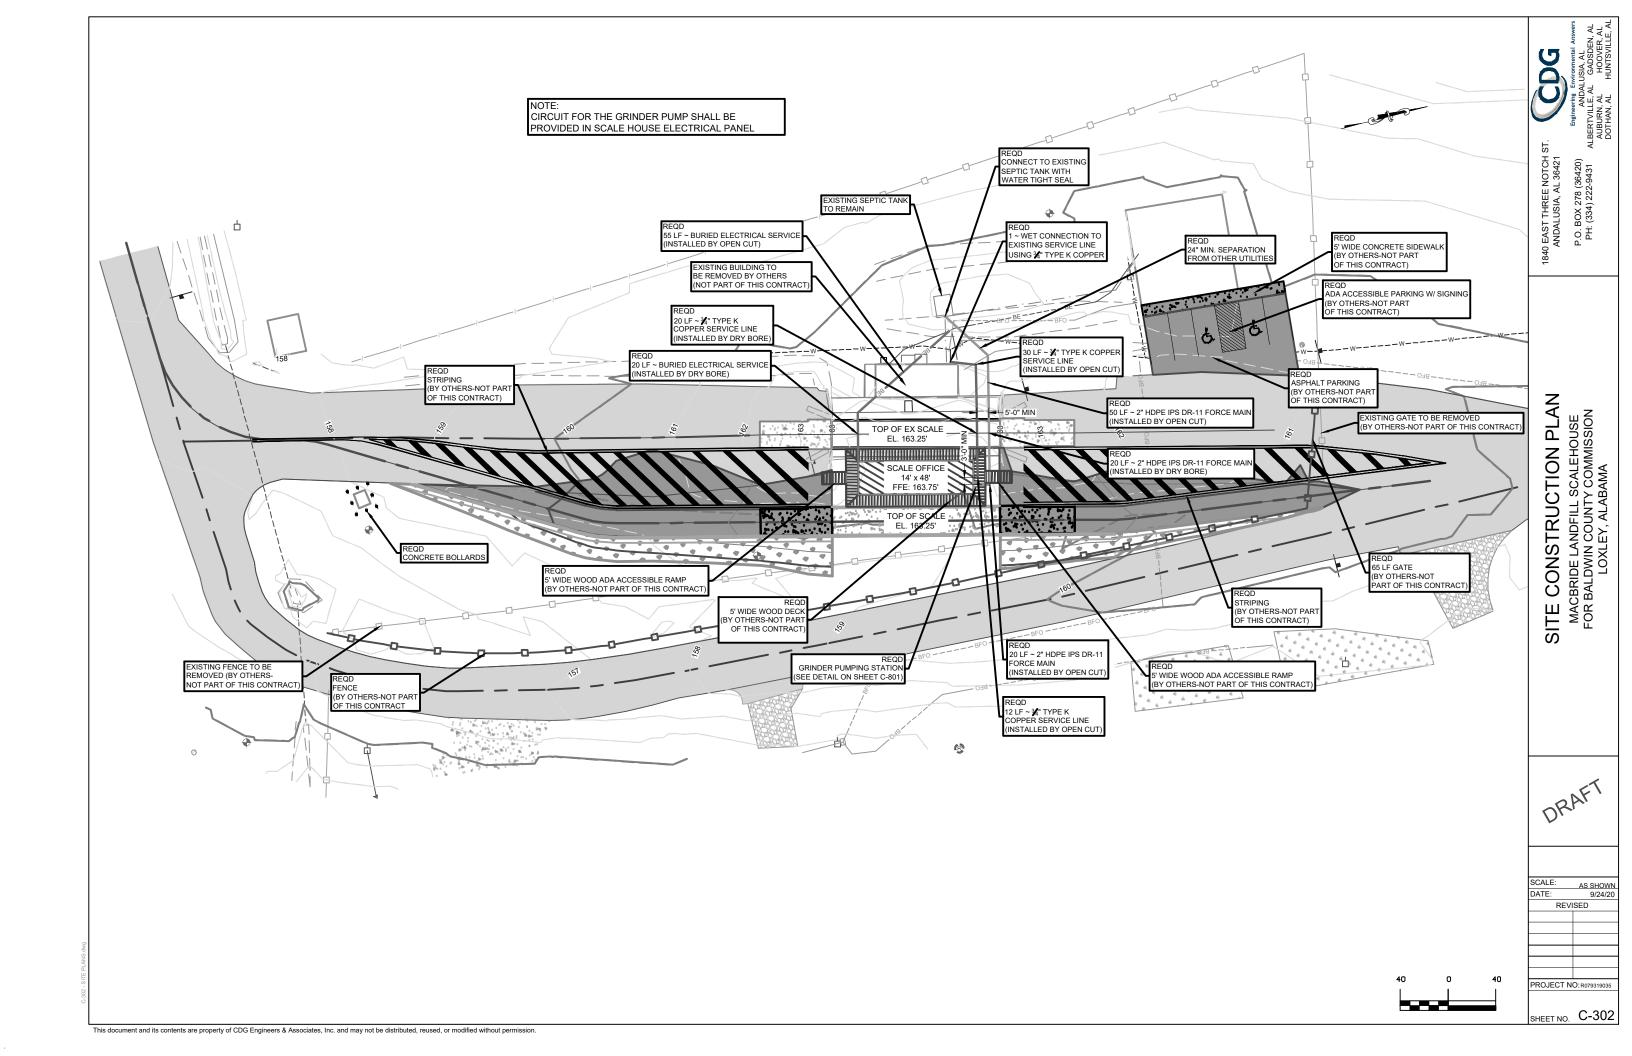

DESK STAFF **PUBLIC STORAGE** 13' x 8' COUNTER LOBBY 13' X 6' DESK

General 14' x 48' Scale office

672 square feet

Business occupancy

Alabama label, AMHC approval

International Building Code

MBI seal

Wind speed 150 MPH Vult

5# Ground snow load Roof load

Frame 14' x 48' perimeter frame with 12" I beam

Removable hitch

8" steel floor joists at 16", welded inside of frame

(2) 6000# brake axles with 14 ply tires

(2) 6000# idler axles with 14 ply tires

Floor Woven nylon impregnated bottom board

R-30 Unfaced insulation

Two layers 5/8" tongue and groove plywood floor decking

LVT plank, 20 mil, choice of factory colors 4" rubber base cove throughout with pre-molded inside & outside corners

No floor covering or base cove in storage room

Walls

Single top and single bottom steel track

2" x 4" steel joists @ 16" on center, 8' 6" interior wall

R-13 Unfaced insulation interior walls

2' x 6" steel joists @ 16" on center, 8' 6" exterior wall

R-21 Kraft faced exterior walls

½" gypsum, tape/mud/paint over ½" hush board 3 coats of paint; primer and two finish coats

Fiberlite by Nudo FRP in restrooms, choice of colors

1/2" unfinished moisture resistant gypsum on storage room walls

(1) 36" x 36" pass thru window

Interior doors (2) 36" x 80"

solid birch slab doors in bronze Redi-frame

(2) Door closers

(2) Privacy lever locks

Roof Gable roof with hip on front end, 3:12 pitch

8" overhang on all sides 26 gauge Hi-rib steel roofing Steel trusses at 16" on center

5/8" plywood decking 2' x 2' suspended ceiling at 8' above finished floor

R-38 Unfaced insulation held up with netting

Plumbing (2) Single ADA restrooms

PEX supply lines

PVC waste, stub out below bottom board

(2) Wall hung sinks with mirror in stainless steel frame, Bobrick or equal

(2) Vinyl anti scald cover for trap & supply

(2) ADA toilet with Sloan flush valve. 3 grab bars

(1) 20 gallon water heater, Lo-Boy located under the cabinet (1) Mop sink with legs and faucet located in storage room

(1) Double stainless steel sink with gooseneck faucet

(2) Stainless steel toilet paper dispensers, B 264

(2) Stainless steel paper towel dispensers, B 262

(2) Stainless steel waste receptacles, B 279 (2) Stainless steel soap dispensers, B 2111

Cabinets 12 Linear feet of high pressure laminate base

9 Linear feet of HPL overhead cabinets 16 Linear feet of HPL desktop with (4) grommets

26 Linear feet of HPL writing ledge at 44" AFF (1) 4 x 4 plywood phone board with fire retardant paint

(1) Semi recessed fire extinguisher cabinet with 10# fire extinguisher

Electrical (1) 125 AMP, single phase

Copper romex wiring with MC in ceiling cavity only

20-AMP receptacles per code

(3) GFCI receptacles

(1) Dedicated receptacle for the refrigerator

(1) Exterior GFI with locking cover

(1) Heat tape receptacle under the building

(6) 2 x 4 junction boxes at 16" above finished floor with conduit stub outs

(2) Exit/emergency combo with remote heads

(8) 2' x 4' LED flat panel lights, 48 watt, 5070 lumens, 4000K in T grid

(6) Occupancy sensors

(5) LED porch lights with photocell (18W)

HVAC (1) 3 ton wall hung HVAC units with 10kw heat, dehumidification (11 EER) (1) 7-day programmable thermostat with humidity control

Plenum wall

Galvanized metal duct supply and return (2) 100 CFM vent fans

Exterior 5/8" plywood sheathing, full wrap

Moisture resistant house wrap, full perimeter

26 Gauge Hi-Rib steel siding and trim

(6) 36" x 48" fixed windows in bronze aluminum frame,

Low E, insulated

(6) 2" faux blinds

(4) 36" x 80" Steel doors in steel jamb

(3) 6" x 30" wire mesh view blocks; storage room door is blank

(4) closers, keyed levers/deadbolt (all doors keyed alike)

Steel skirting or equivalent

Foundation Poured footers required per approved drawings by the factory engineer.

All footers shall be reinforced and inspected by the

Alabama Manufactured Housing Commission prior to pouring cement. There shall be at least 3 test cylinders, tested weekly after the pour or

the contractor must wait 28 days per State

code before setting the building. Once the cylinder breaks at 3,000 psi, the building may be set upon the footers. After the building is set, all piers must

be mortared with cement in the cells of the piers.

There shall be a 3/8" weld plate embedded into the top of each piers. The I beam frame of the building shall be welded to the weld plate on each

Site Notes The site pad must be crowned or sloped so that storm water

will not pond or flow under the building.

The site must have a 2000 lb. minimum soil compaction

Number and locations to be determined. Communication

Contractor to provide central location for access to

all FCP internal connections for the purpose of connecting

to external network and phone lines.

Cable drops for computer, phone and electrical systems are to be sufficiently accessible to allow future repairs,


maintenance and expansion.

Ethernet and phone outlets (number and type outlet to be determined) are to be installed near electrical outlets,

preferably within three feet.

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SHEET NO. **C-501**

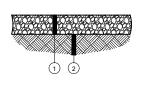

TYPICAL DENSE GRADED BASE SECTION

NOT TO SCALE


- CRUSHED AGGREGATE BASE COURSE, ALDOT 825, TYPE B, 6" COMPACTED THICKNESS, AS PER ALDOT SSHC 2012 OR LATER
- 2) SUB-GRADE (SUB-GRADE (COMPACTED TO 98% STANDARD PROCTOR)

(BY OTHERS-NOT PART OF THIS CONTRACT)

EMBEDMENT REQUIREMENTS NOT TO SCALE (BY OTHERS-NOT PART OF THIS CONTRACT)

COMPACTED SOIL BACKFILL

COMPACTED SOIL BACKFILL

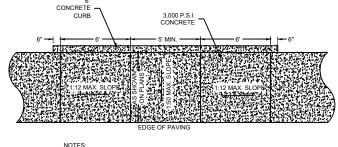

AS SHOWN ON PLANS


1. CUT 1/2" TRANSVERSE DUMMY JOINTS AT 6'-0" O.C. 2. EXPANSION JOINTS REQUIRED AT 30' O.C.


CONCRETE SIDEWALK

NOT TO SCALE
(BY OTHERS-NOT PART OF THIS CONTRACT

1:50 MAX

3 000 P.S.I. CONCRETE

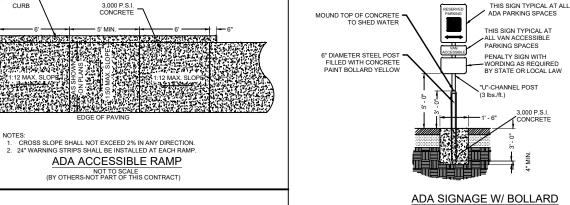

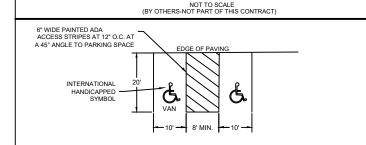

- 1. ALL PARKING LOT STRIPING TO BE TRAFFIC BEARING PAINT.


 2. ALL PARKING LOT STRIPING SHALL RECEIVE TWO COATS OF TRAFFIC PAINT.

 3. PAINT COLOR TO BE GLIDDEN BOLLARD BLUE #61803 OR APPROVED ALTERNATIVE BY ENGINEER

 4. ALL PARKING LOT STRIPING TO BE A MIN. OF 4" WIDE UNLESS OTHERWISE NOTED.

TYPICAL STRIPING DETAILS

NOT TO SCALE
(BY OTHERS-NOT PART OF THIS CONTRACT)

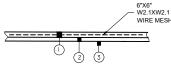

- ONCRETE PAVEMENT (4,000 P.S.I.), 5" THICK, WITH 10' JOINTS
- © CRUSHED AGGREGATE BASE COURSE, ALDOT 825, TYPE B, 6" COMPACTED THICKNESS
- (3) SUB-GRADE (COMPACTED TO 98% STANDARD PROCTOR)

TYPICAL LIGHT DUTY CONCRETE PAVING SECTION

NOT TO SCALE (BY OTHERS-NOT PART OF THIS CONTRACT)


HOG RINGS OR FENCE TIES FOLD TOP TO GET FOUR (4) THICKNESSES OF GEOTEXTILE 3'-0" MIN. -GEOTEXTILE WOVEN WIRE (14 GAUGE MIN.) 2 WIRES TWISTED TO SINGING TAUTNESS (12 GA. MINIMUM) TIE-BACK TO BE USED AS NECESSARY VOVEN WIRE TO ASSIST WITH SILT FENCE TURN-OVER: 6" BELOW GRADE 2 WIRES (12 GAUGE MIN.) TWISTED TO SINGING TAUTNESS 5' METAL POST GROUND LINE MECHANICALLY TRENCHED (FULL DEPTH OF TAIL) BACKFILL GEOTEXTILE WITH EARTH. Z_{GEOTEXTILE} 12" BELOW GRADE HOLES SHALL BE PROPERLY BACKFILLED AND TAMPED WITH SOIL TO APPROXIMATE DENSITY OF EXISTING SOIL. SECTION **ELEVATION**

TYPE "A" SILT FENCE SEDIMENT BARRIER DETAIL

(BY OTHERS-NOT PART OF THIS CONTRACT)

GENERAL NOTES:

- SILT FENCE IS A TEMPORARY EROSION CONTROL ITEMS THAT SHALL BE ERECTED OPPOSITE ERODIBLE AREAS SUCH AS NEWLY GRADED FILL SLOPES AND ADJACENT TO STREAMS, CHANNELS, STREETS, CURBS, ETC.
- 2. SILT FENCE SHOULD BE PLACED WELL INSIDE CLEARING LIMITS. THIS WILL ALLOW ROOM FOR A BACK-UP FENCE IF FIRST BECOMES FULL. SILT FENCES SHALL BE IN PLACE PRIOR TO ANY CONSTRUCTION OPERATION.
- 3. WHEREVER POSSIBLE, SILT FENCES SHALL BE CONSTRUCTED ACROSS A FLAT AREA IN THE SHAPE OF A HORSESHOE. THIS AIDS IN PONDING OF RUNOFF AND FACILITATES SEDIMENTATION.
- 4. SILT FENCE SHALL BE FASTENED TO UPSTREAM SIDE OF POST & WIRE BY HOG RINGS OR FENCE TIES. (17 GAUGE MIN.)
- 5. REMOVE SEDIMENT DEPOSITS WHEN THEY REACH A DEPTH OF 15" OR 1/2 THE HEIGHT OF THE FENCE AS INSTALLED TO PROVIDE ADEQUATE STORAGE VOLUME FOR THE NEXT RAIN EVENT AND TO REDUCE PRESSURE ON THE FENCE
- 6 SHOULD THE SILT FENCE BECOME DAMAGED OR OTHERWISE INFEFECTIVE WHILE THE BARRIER IS STILL NECESSARY, IT SHALL BE REPAIRED PROMPTLY WITH A NEW SECTION OF FILTER OVERLAPPING A MINIMUM OF 12 INCHES ON EACH SIDE OF A
- 7. AFTER THE CONSTRUCTION AREA IS STABILIZED AND EROSION ACTIVITY CURTAILED, SILT FENCES SHALL BE REMOVED AND THE DISTURBED AREA FROM REMOVAL SHALL BE GRASSED TO STABILIZE.

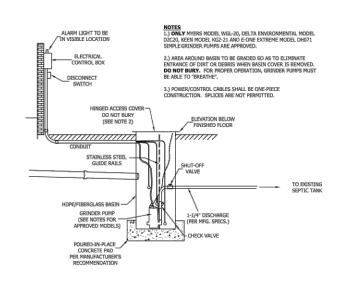

GRINDER PUMP NOT TO SCALE

SCALE: AS SHOWN DATE: 9/24/20 REVISED PROJECT NO: R079319035

SHEET NO. C-801

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MACBRIDE LANDFILL SCALEHOUSE OR BALDWIN COUNTY COMMISSION LOXLEY, ALABAMA **DETAILS**